44 Park Road Leppington NSW 2179



DRAWING LIST

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000	COVER PAGE	
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111	GROUND FLOOR PLAN	1:200
112	ROOF PLAN	1:200
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601	FENCE DETAILS	1:250
602	FENCE DETAILS	1:20

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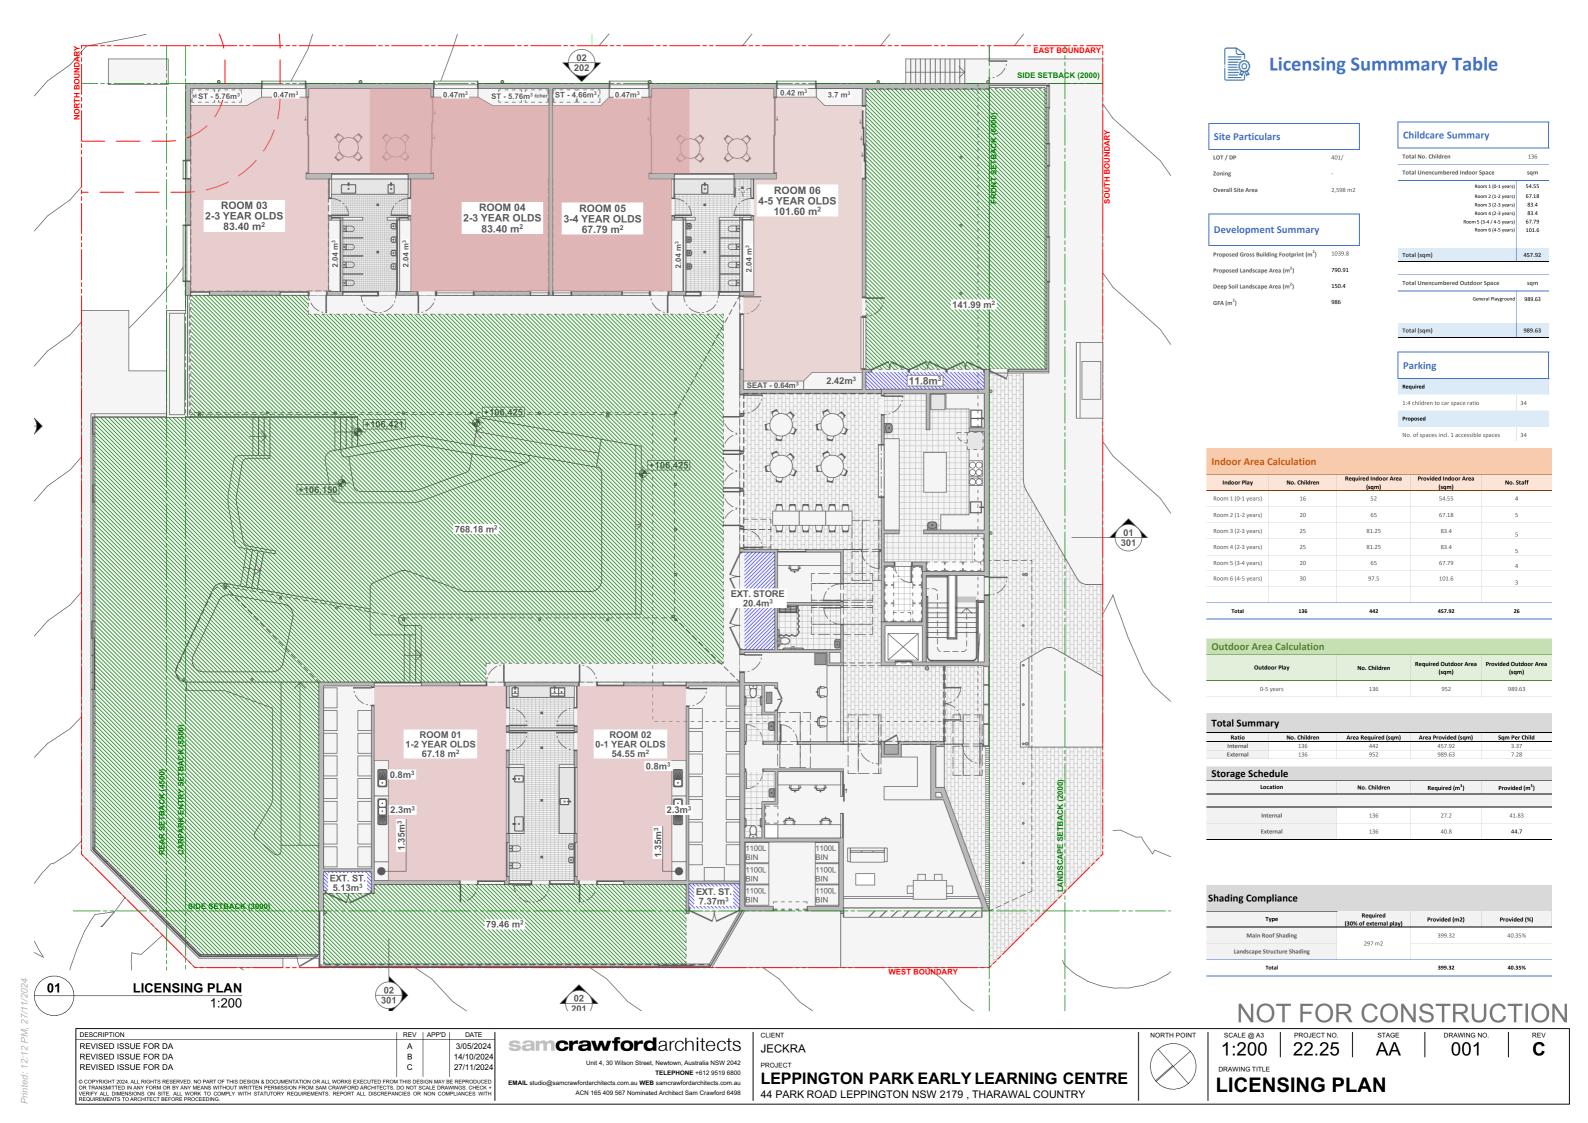
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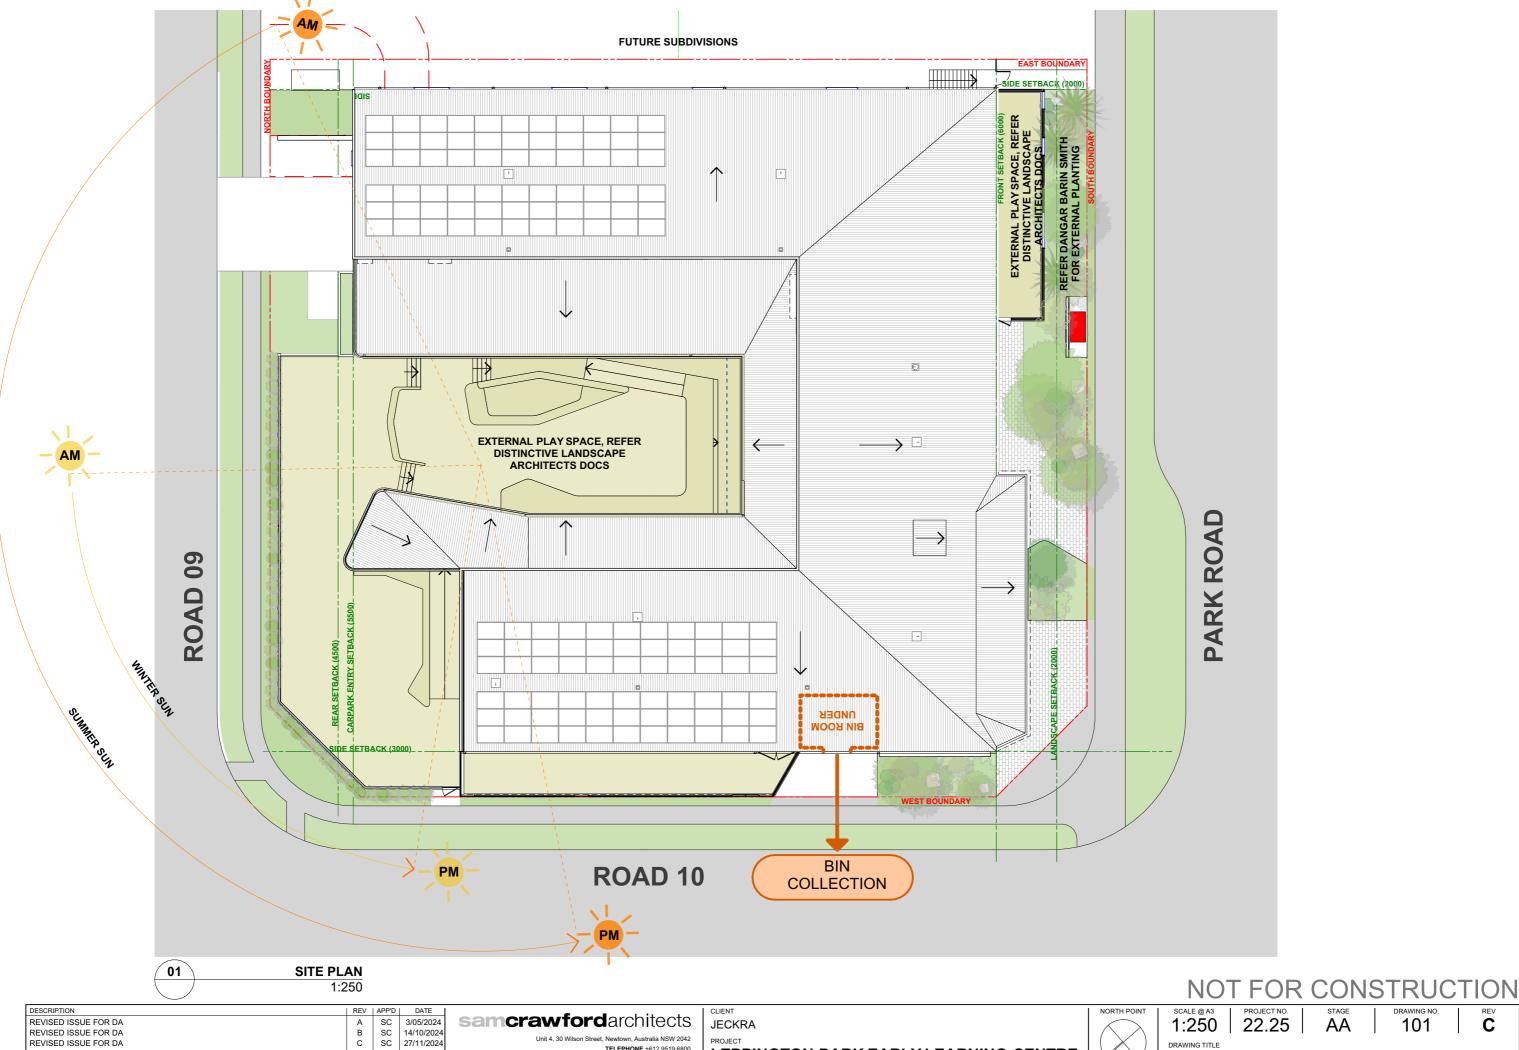
TELEPHONE +612 9519 6800

JECKRA

LEPPINGTON PARK EARLY LEARNING CENTRE
44 PARK ROAD LEPPINGTON NSW 2179, THARAWAL COUNTRY







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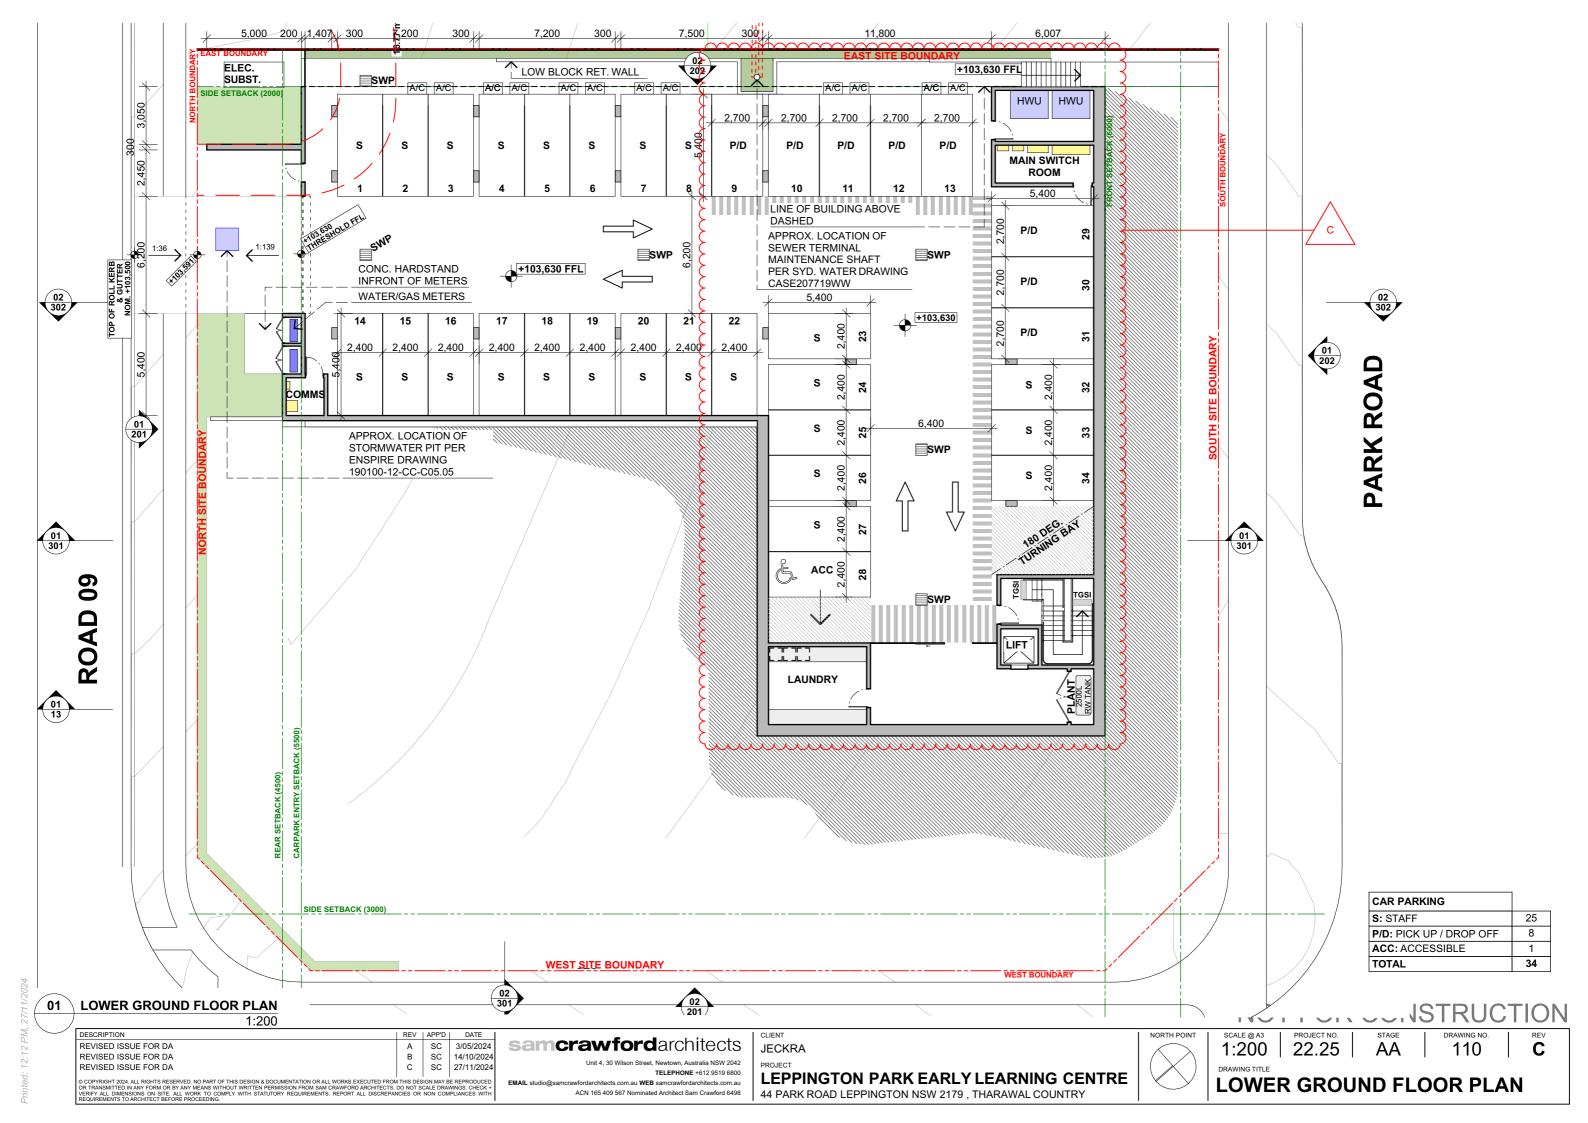
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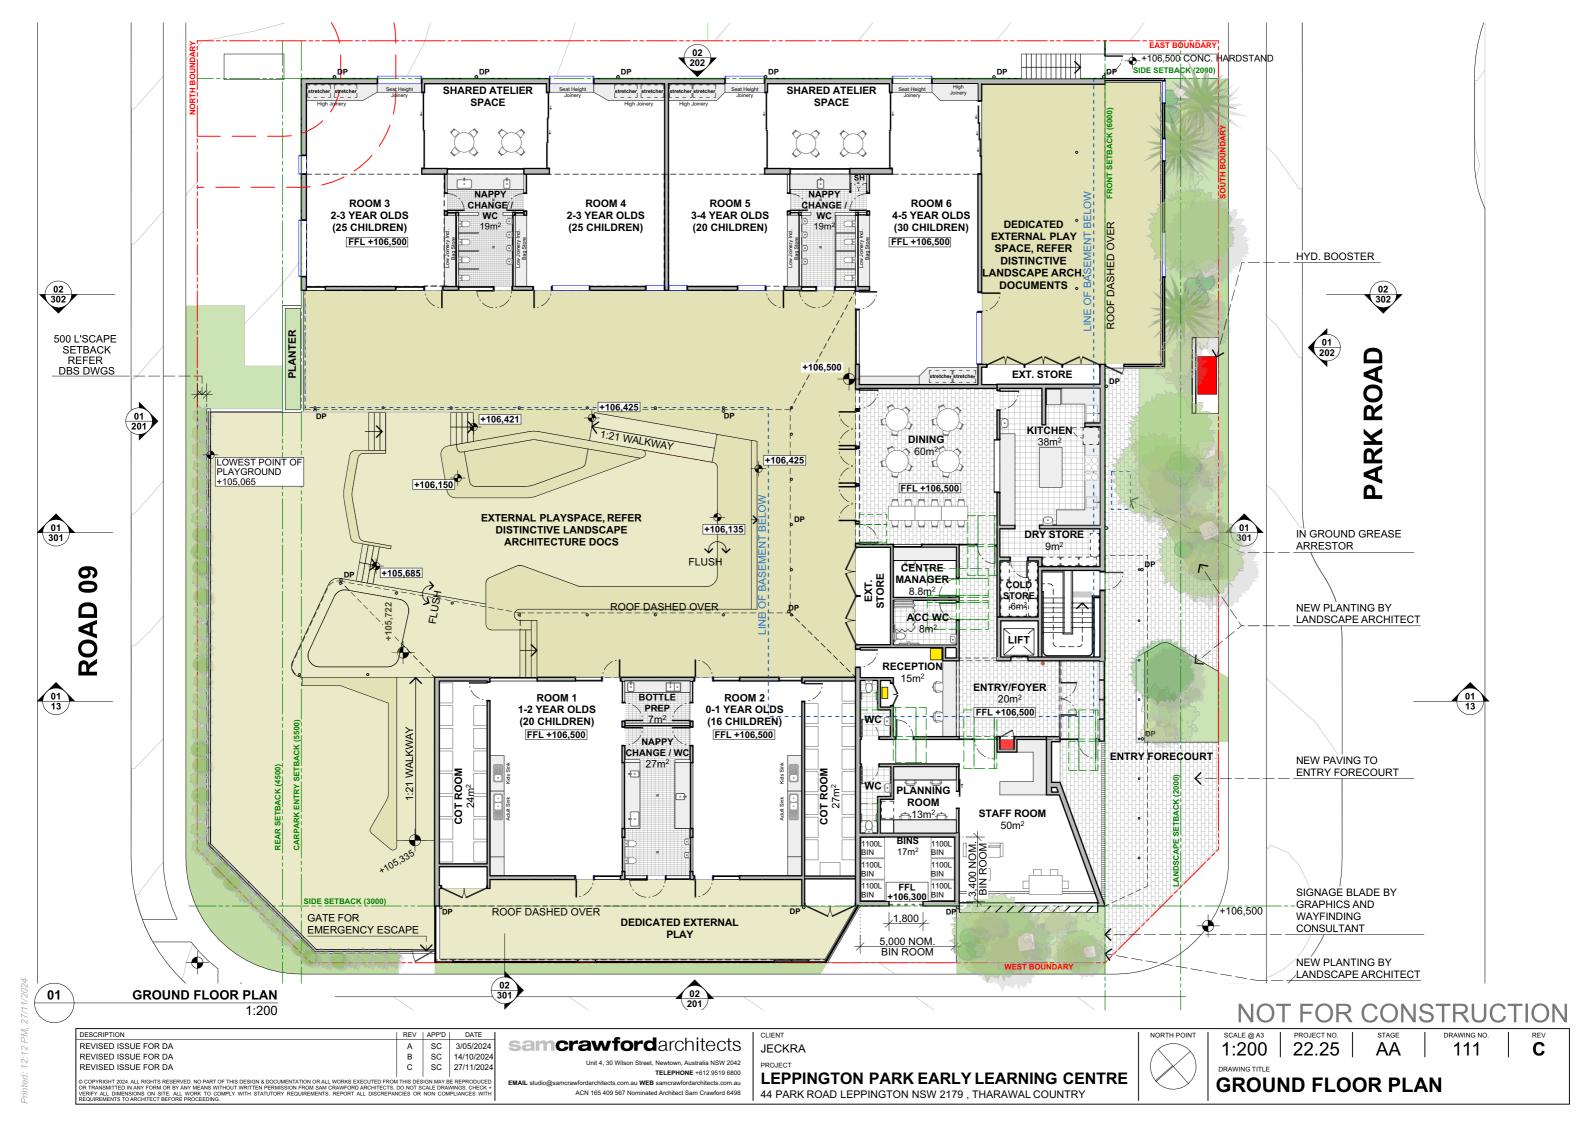
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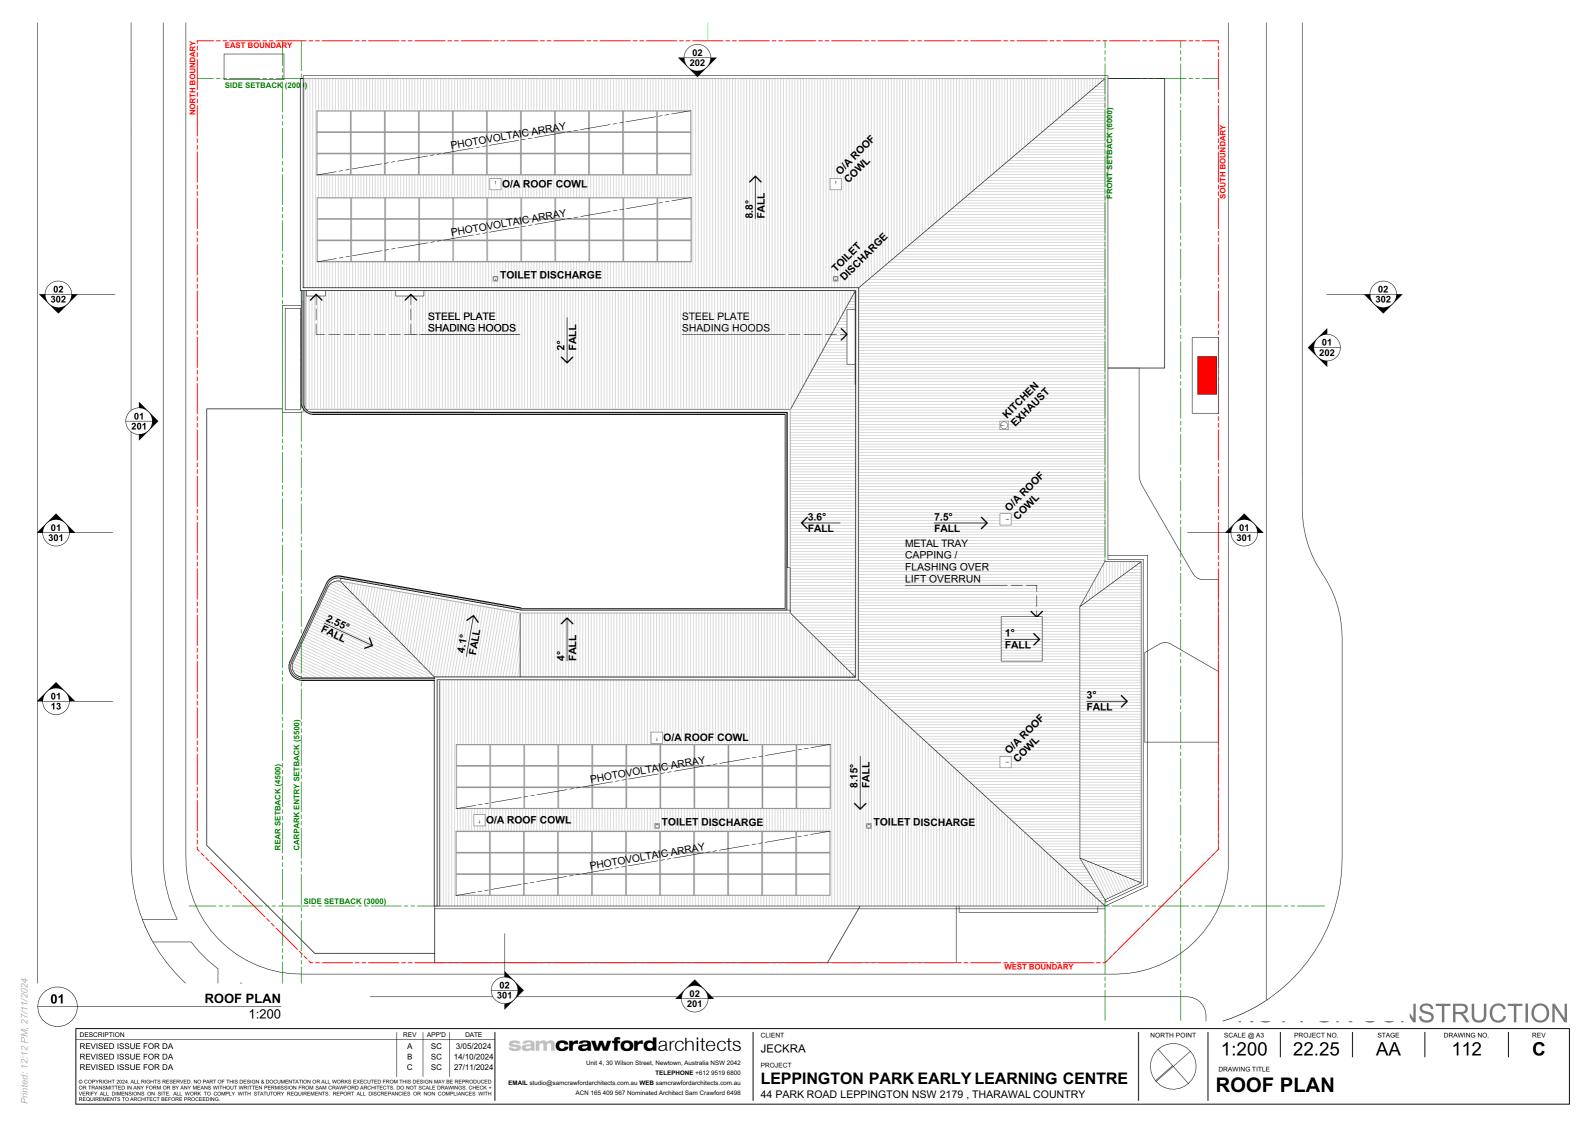
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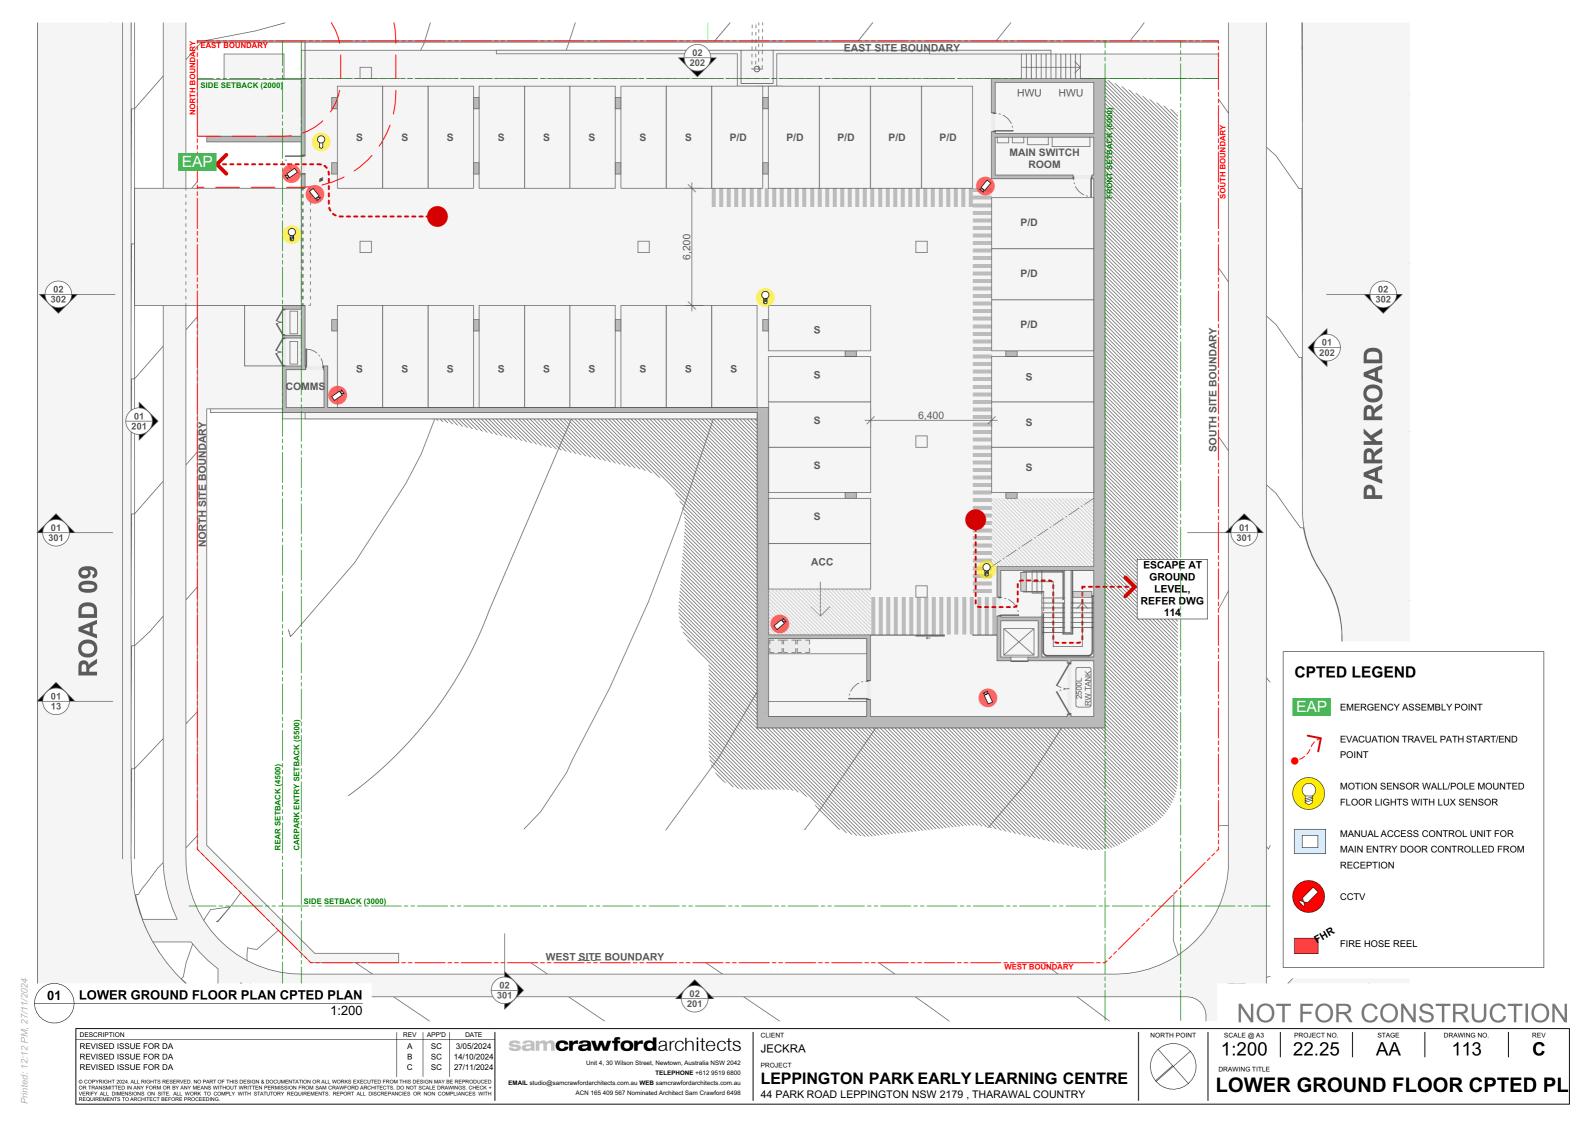
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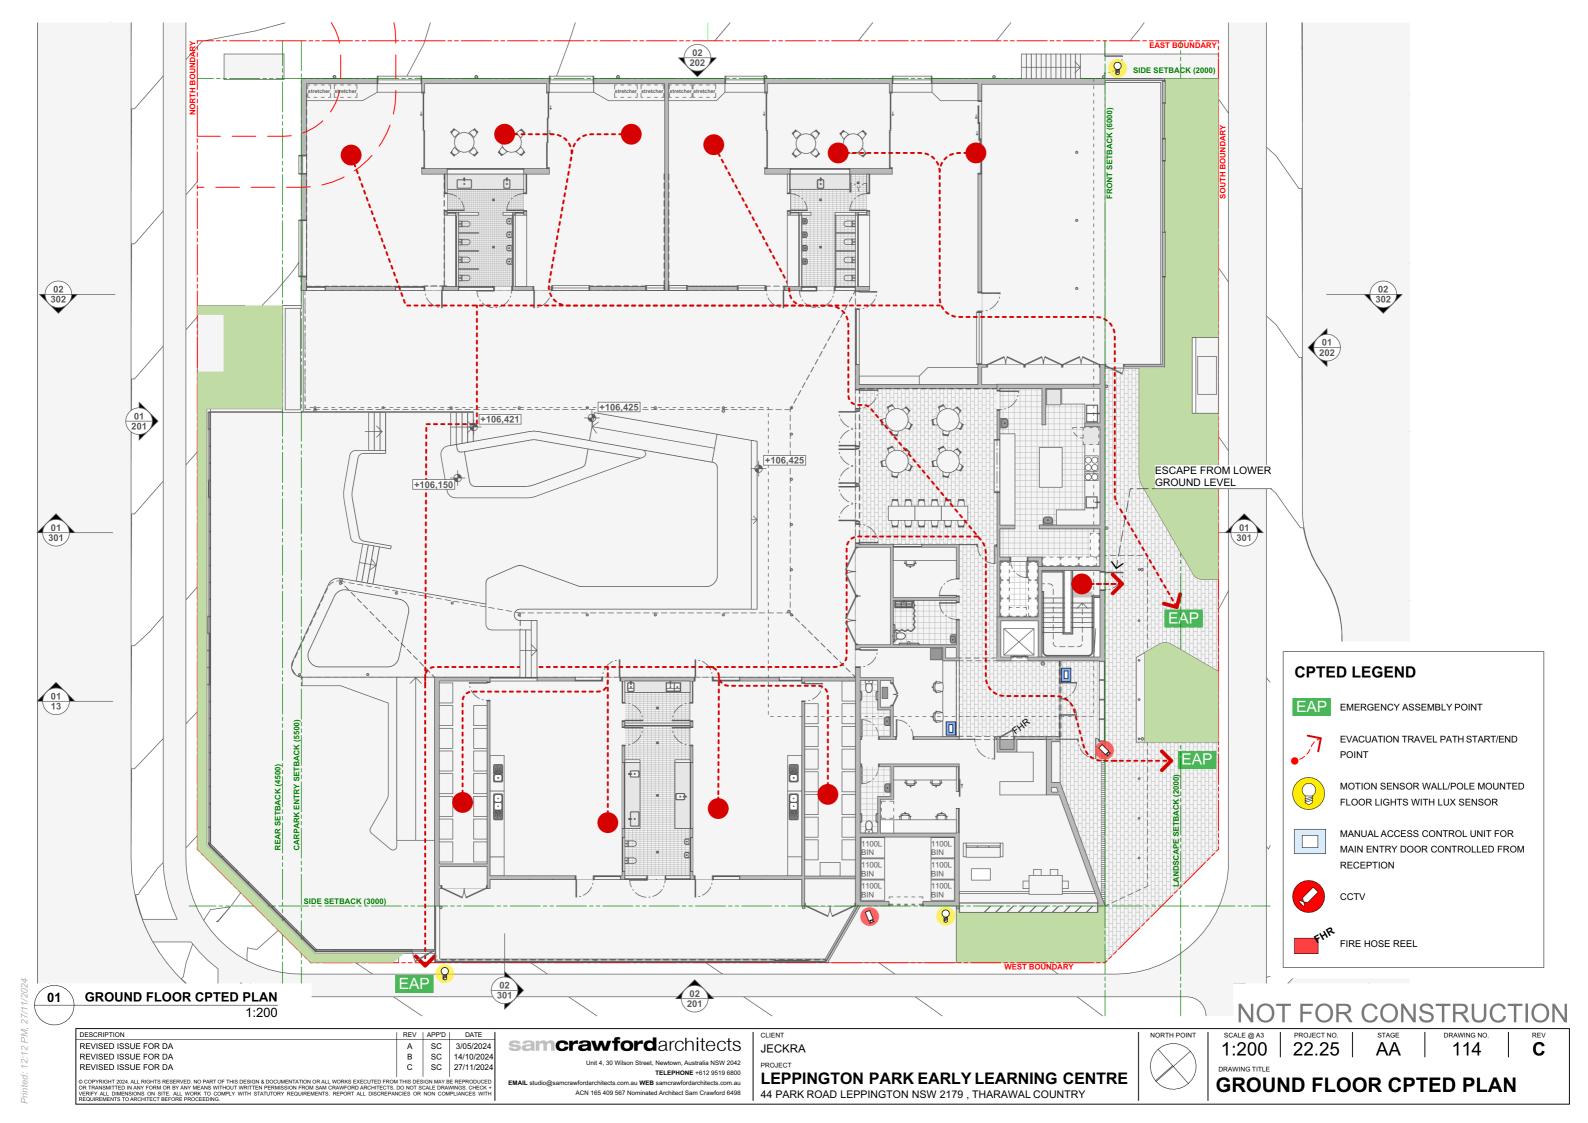
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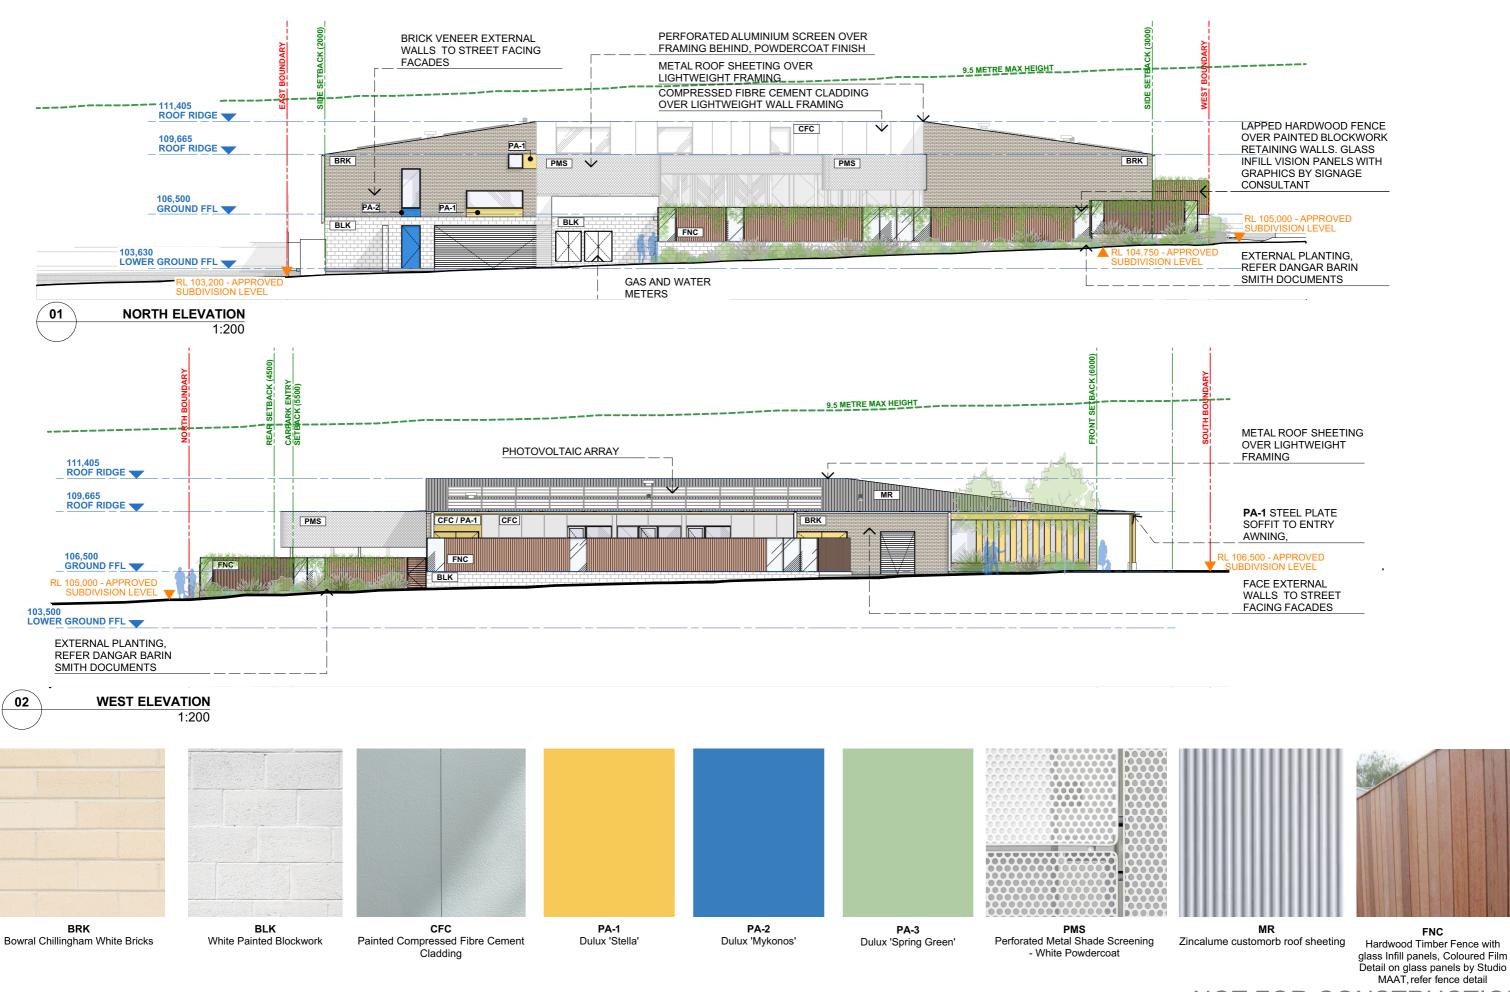












 DESCRIPTION
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 REVISED ISSUE FOR DA
 A
 SC
 3/05/2024

 REVISED ISSUE FOR DA
 B
 SC
 14/10/2024

 REVISED ISSUE FOR DA
 C
 SC
 27/11/2024

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ACN 165 409 567 Nominated Architect Sam Crawford 6498

JECKRA
PROJECT

LEPPINGTON PARK EARLY LEARNING CENTRE
44 PARK ROAD LEPPINGTON NSW 2179, THARAWAL COUNTRY


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 SCALE @ A3
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NORTH AND WEST ELEVATIONS



REVISED ISSUE FOR DA

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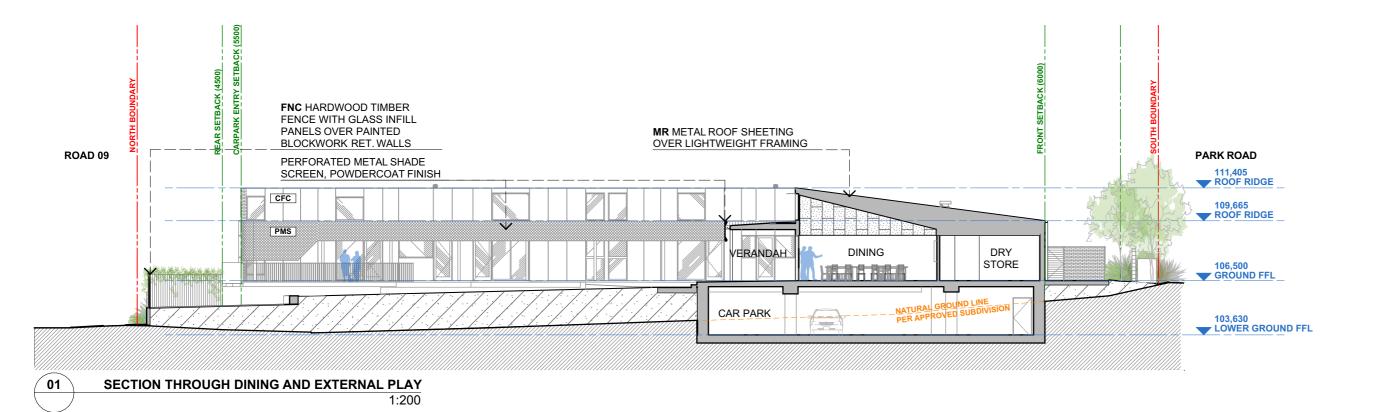
samcrawfordarchitects **JECKRA** TELEPHONE +612 9519 6800 LEPPINGTON PARK EARLY LEARNING CENTRE cts.com.au WEB samcrawfordarchitects.com.au ACN 165 409 567 Nominated Architect Sam Crawford 6498 44 PARK ROAD LEPPINGTON NSW 2179, THARAWAL COUNTRY


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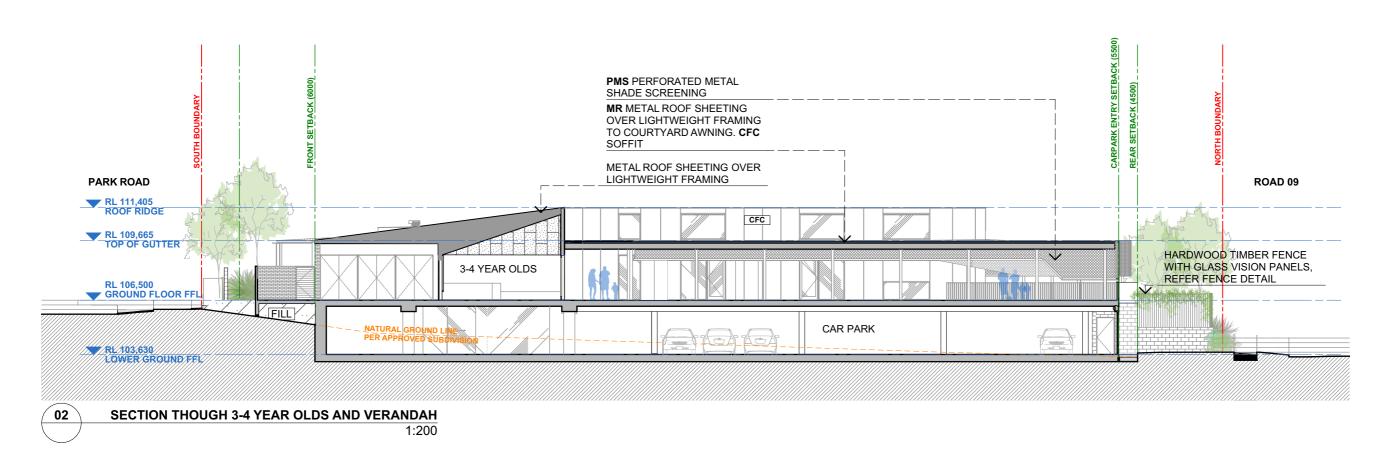
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DESCRIPTION DATE SCALE @ A3 PROJECT NO. REV | APP'D | CLIENT SC SC SC **samcrawford**architects 22.25 302 REVISED ISSUE FOR DA 3/05/2024 1:200 **JECKRA** REVISED ISSUE FOR DA 14/10/2024 TELEPHONE +612 9519 6800 LEPPINGTON PARK EARLY LEARNING CENTRE **SECTIONS** COPYRIGHT 2024. ALL RIGHTS RESERVED. NO PART OF THIS DESIGN & DOCUMENTATION OR ALL WORKS EXECUTED FROM THIS DESIGN MAY BE REPRODUCE!
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REVISED ISSUE FOR DA A 3/05/2024
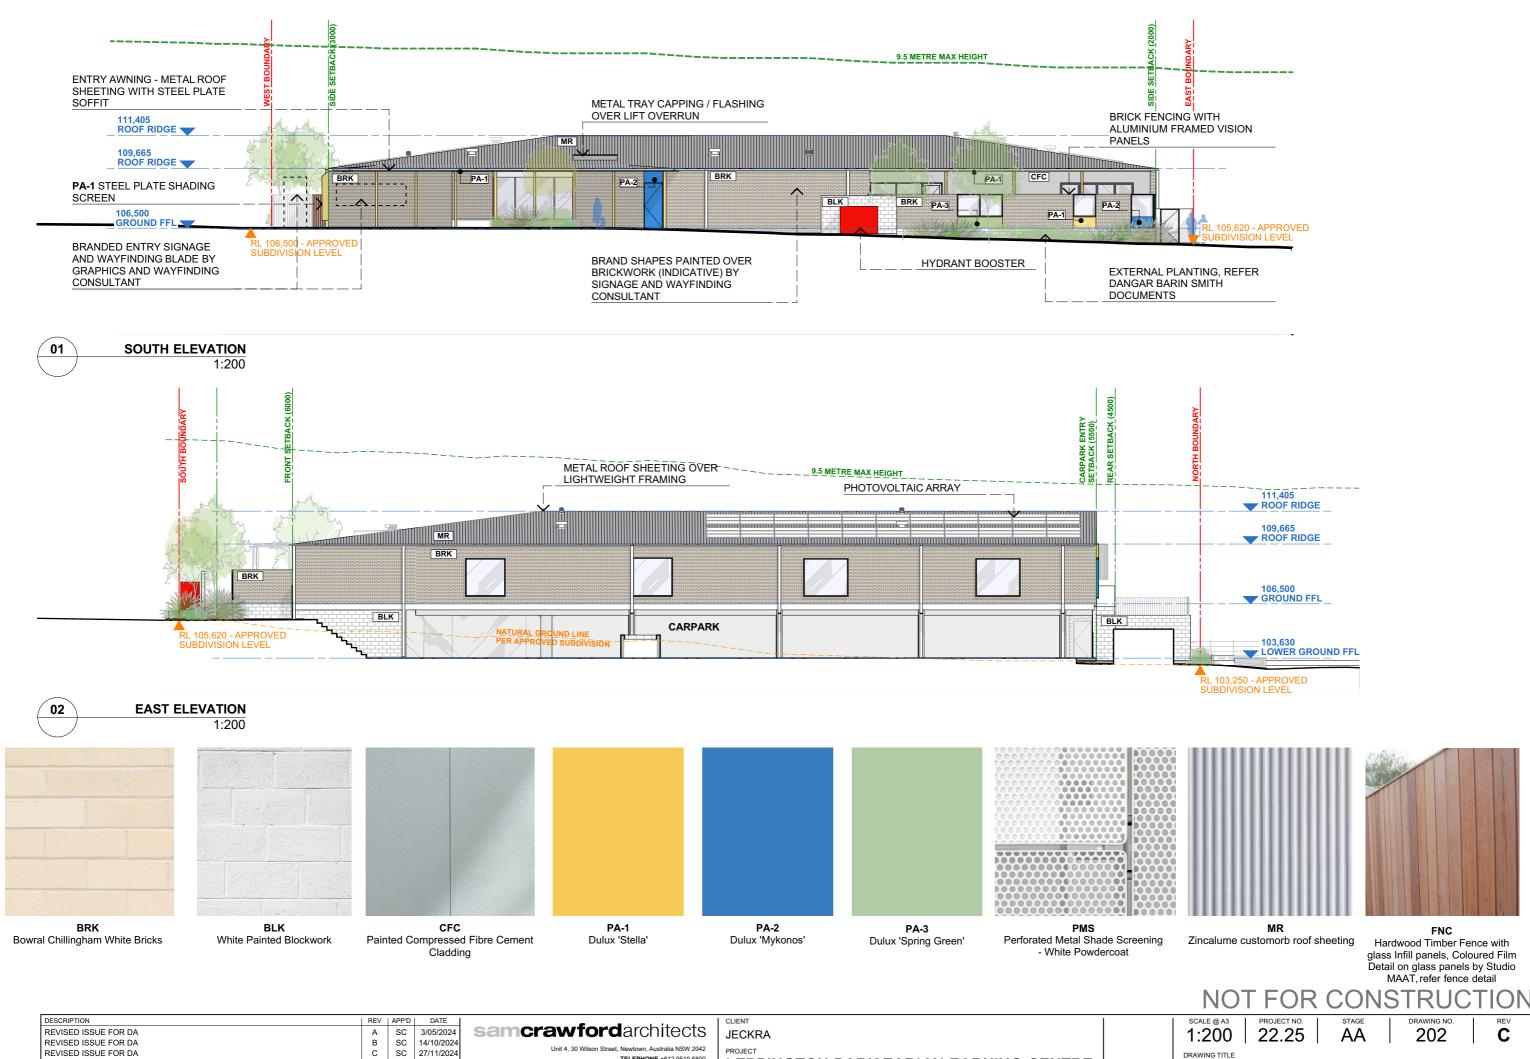
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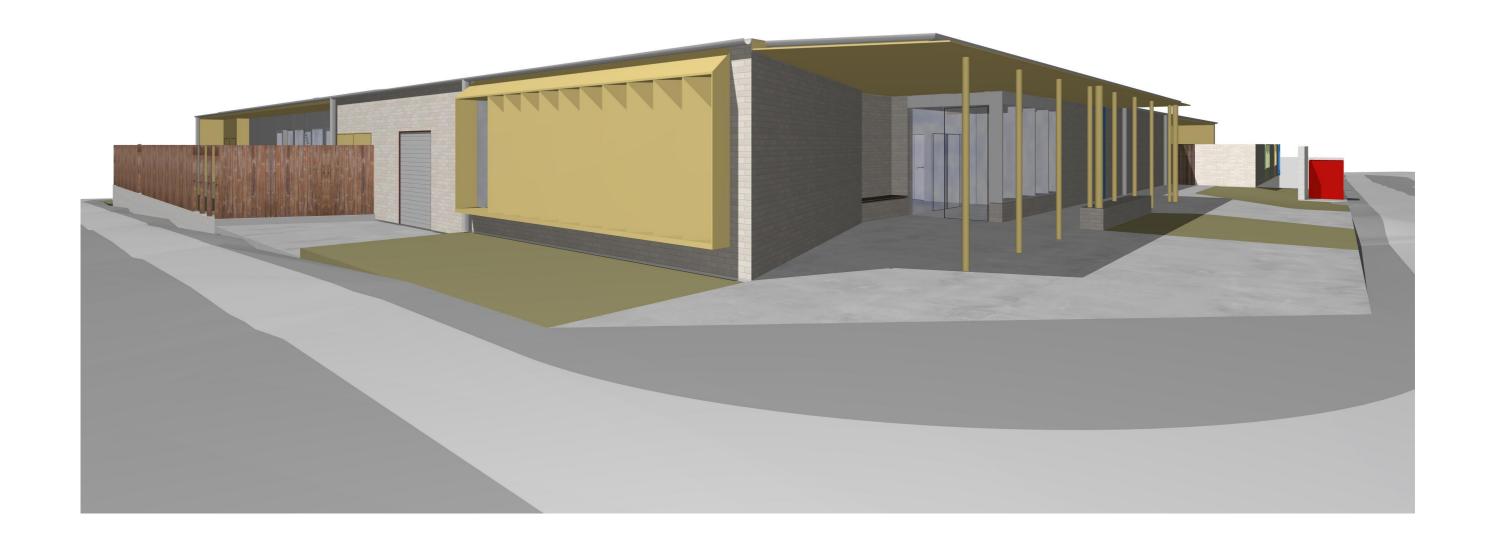
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LEPPINGTON PARK EARLY LEARNING CENTRE
44 PARK ROAD LEPPINGTON NSW 2179, THARAWAL COUNTRY

PROJECT NO. 22.25

STAGE DRAWING NO. 401

PERSPECTIVES

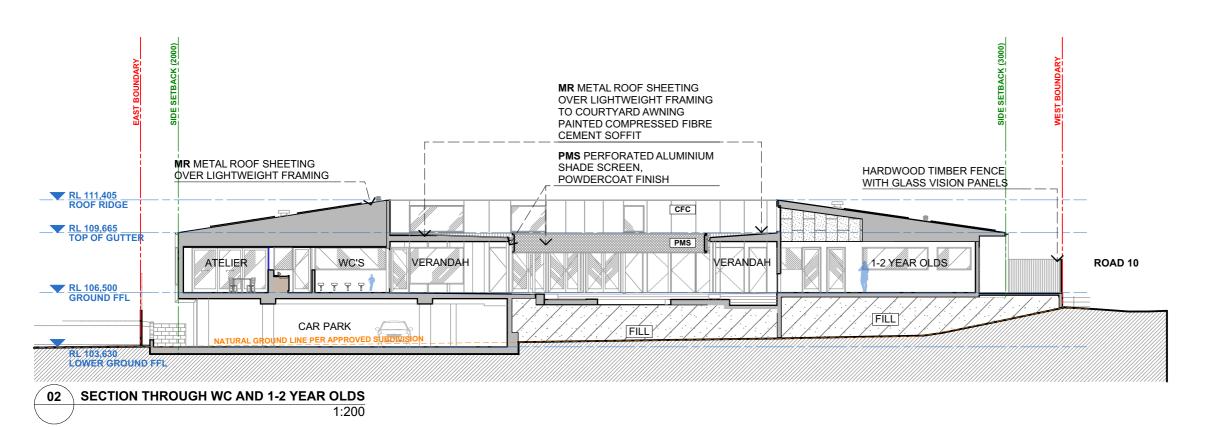

DRAWING NO. 402

 DESCRIPTION
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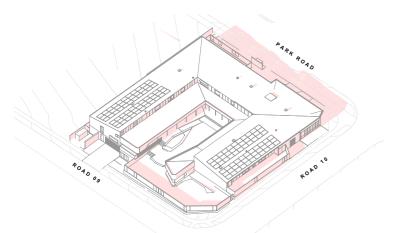
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LEPPINGTON PARK EARLY LEARNING CENTRE
44 PARK ROAD LEPPINGTON NSW 2179, THARAWAL COUNTRY

PROJECT NO. STAGE 22.25 AA

DRAWING TITLE


PERSPECTIVES



3D SHADOWS - JUNE 21ST 9AM


3D SHADOWS - JUNE 21ST 12PM 1:1000

ROAD 09

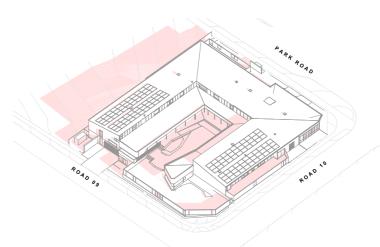

3D SHADOWS - JUNE 21ST 3PM

ROAD 09

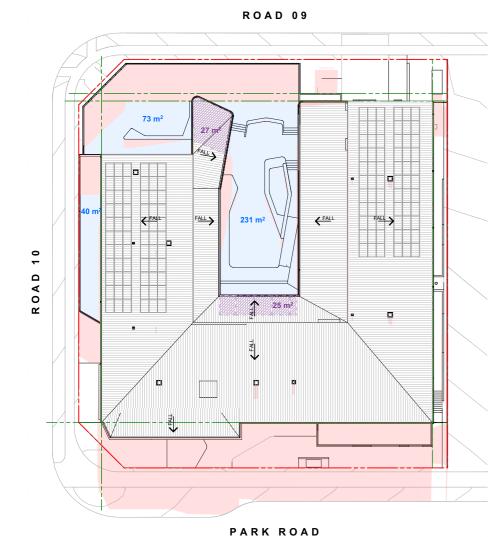

ROAD 1 0

₹FALL OAD 19 m²

PARK ROAD

SHADOWS - JUNE 21ST 9AM 1:500

Total External Playspace - 989m²

Shadows cast by Proposed

Area of Unshaded Playground Space: 344m²

Area of Unshaded Playground Space Under Roof: 52m²

Total Area of Unshaded Playground Space: 396m²

% Playspace in sunlight - 40%

SHADOWS - JUNE 21ST 12PM

Total External Playspace - 989m²

Shadows cast by Proposed

Area of Unshaded Playground Space: 317m²

Area of Unshaded Playground Space Under Roof: 73m²

Total Area of Unshaded Playground Space: 390m²

% Playspace in sunlight - 39%

PARK ROAD

SHADOWS - JUNE 21ST 3PM 1:500

Total External Playspace - 989m²

Shadows cast by Proposed

Area of Unshaded Playground Space: 167m²

Area of Unshaded Playground Space Under Roof: 135m²

Total Area of Unshaded Playground Space: 302m²

% Playspace in sunlight - 30.5%

CONSTRUCTION

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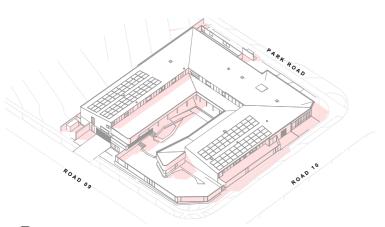
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LEPPINGTON PARK EARLY LEARNING CENTRE 44 PARK ROAD LEPPINGTON NSW 2179, THARAWAL COUNTRY



SCALE @ A3 403 1:500


JUNE 21ST SHADOW



3D SHADOWS - DEC 21ST 9AM

3D SHADOWS - DEC 21ST 12PM 1:1000 3D SHADOWS - DEC 21ST 3PM

ROAD 09

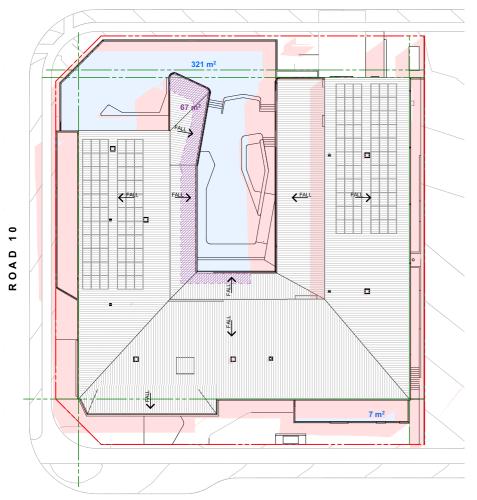

ROAD 09 ROAD □ 30 m²

ROAD 09 **←** FALL OAD

PARK ROAD

SHADOWS - DECEMBER 21ST 9AM

Total External Playspace - 989m²

Shadows cast by Proposed

Area of Unshaded Playground Space: 328m²

Area of Unshaded Playground Space Under Roof: 67m² Total Area of Unshaded Playground Space: 395m²

% Shaded Playspace requirement - 30%

% Playspace in sunlight - 39.9%

% Playspace in Shade - 60.1%

PARK ROAD

SHADOWS - DECEMBER 21ST 12PM 1:500

Total External Playspace - 989m²

Shadows cast by Proposed

Area of Unshaded Playground Space: 534m²

Area of Unshaded Playground Space Under Roof: 6m² Total Area of Unshaded Playground Space: 540m²

% Shaded Playspace requirement - 30%

% Playspace in sunlight - 54%

% Playspace in Shade - 46%

PARK ROAD

SHADOWS - DECEMBER 21ST 3PM 1:500

Total External Playspace - 989m²

Shadows cast by Proposed

Area of Unshaded Playground Space: 455m²

Area of Unshaded Playground Space Under Roof: 21m²

Total Area of Unshaded Playground Space: 476m²

% Shaded Playspace requirement - 30%

% Playspace in sunlight - 48%

% Playspace in Shade - 52%

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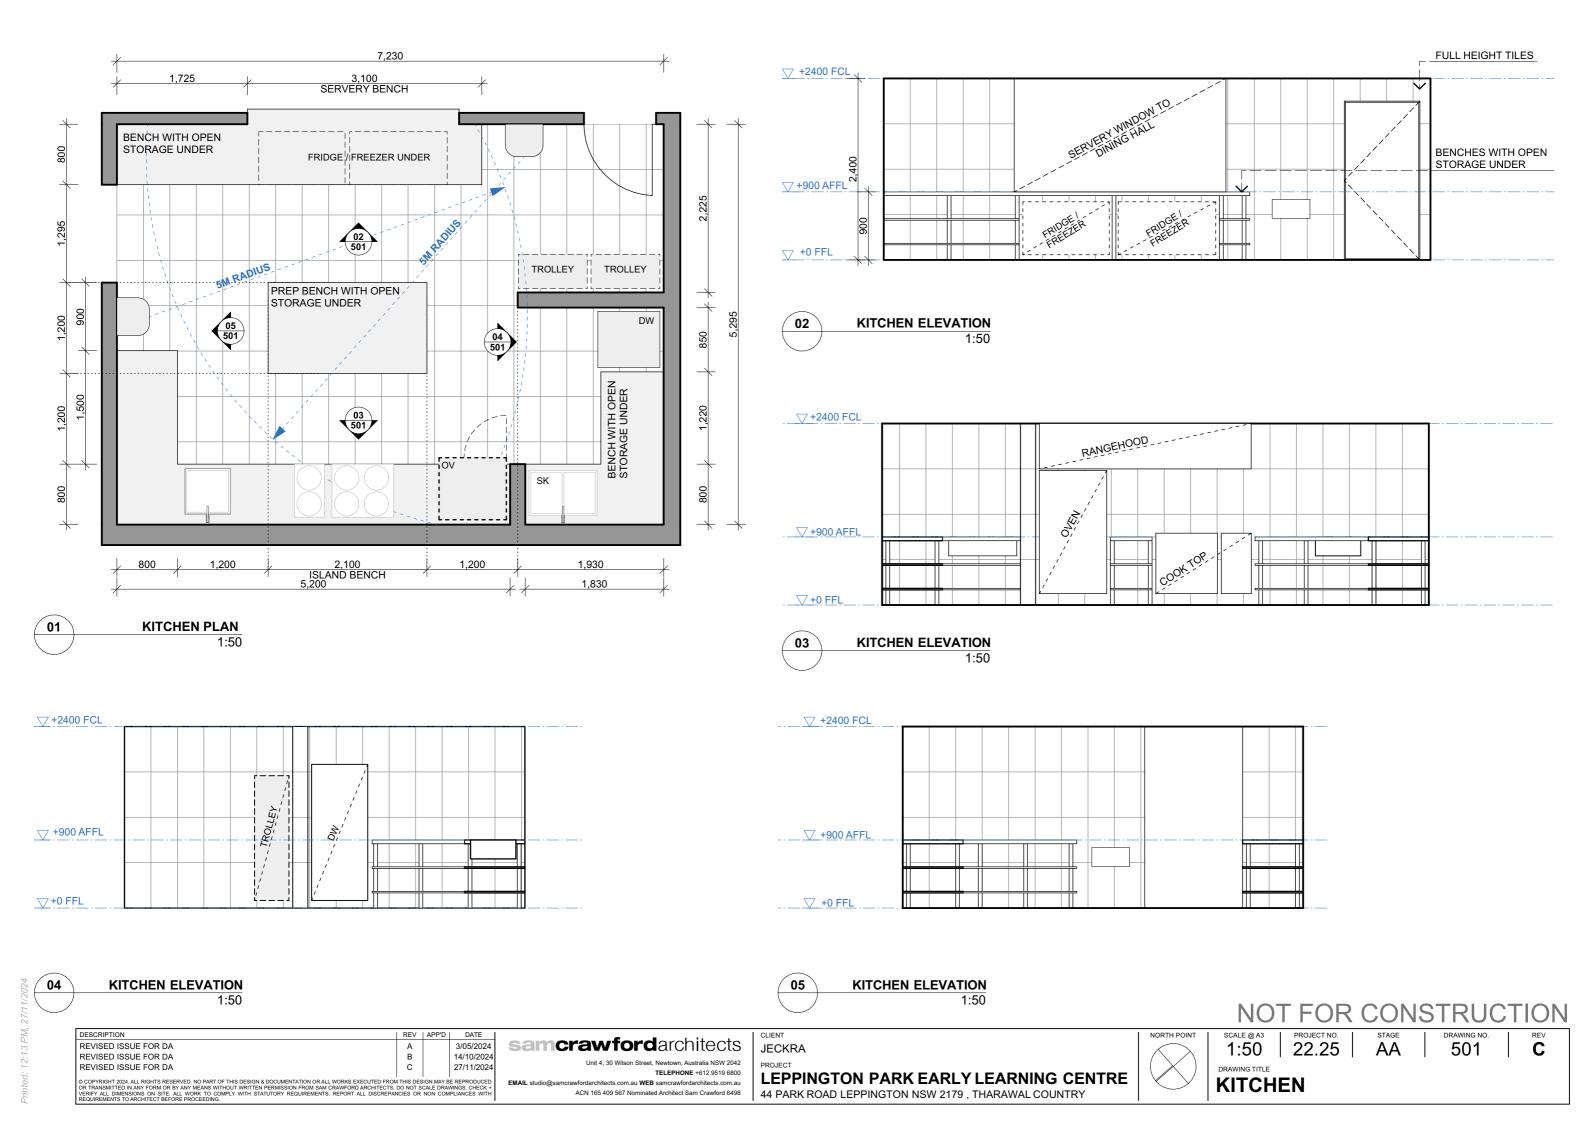
LEPPINGTON PARK EARLY LEARNING CENTRE 44 PARK ROAD LEPPINGTON NSW 2179, THARAWAL COUNTRY





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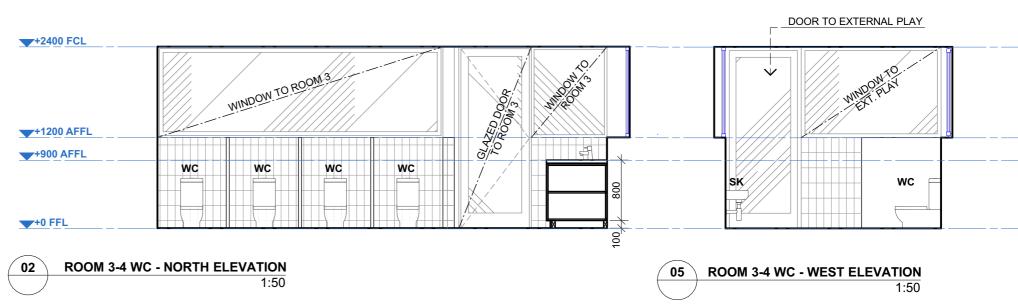
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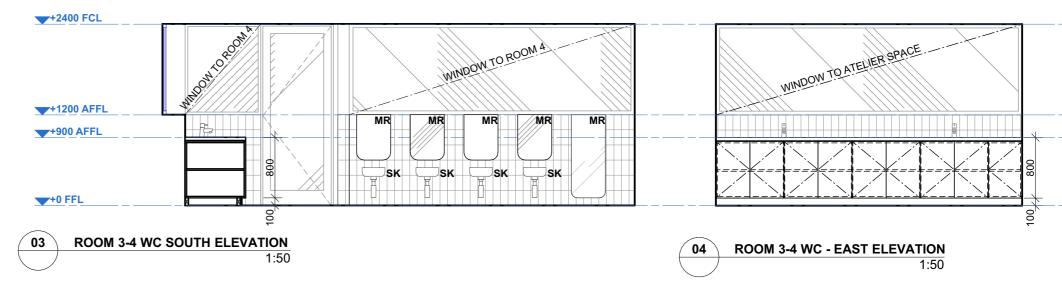
DECEMBER 21ST SHADOW







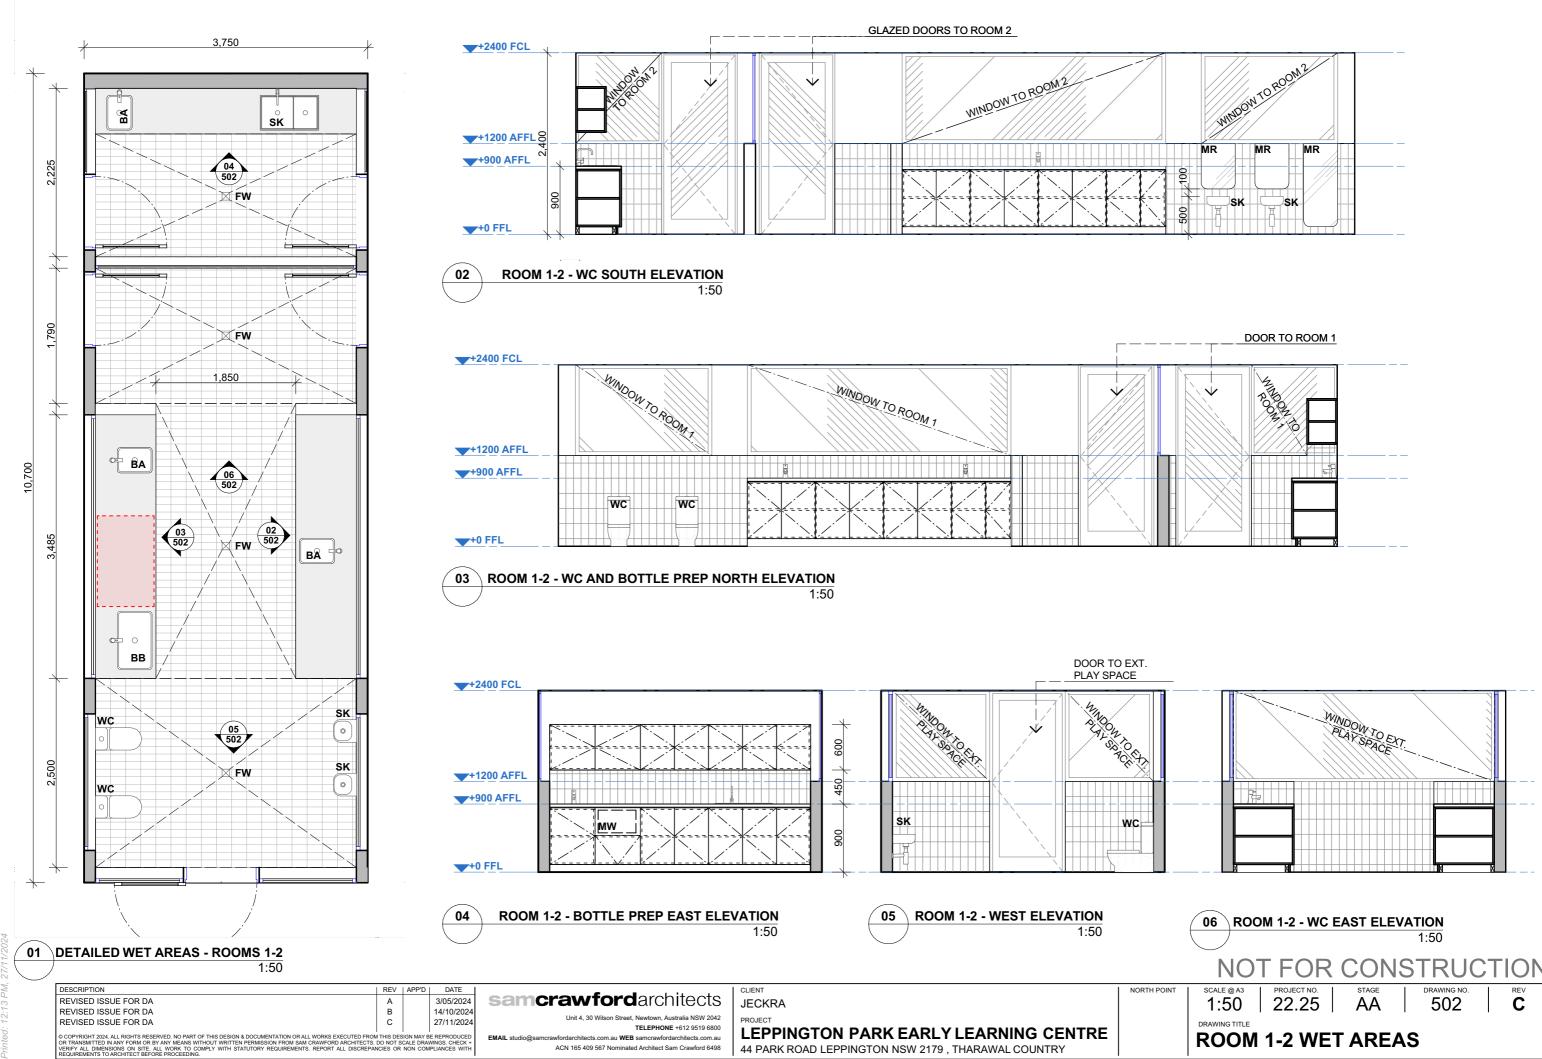

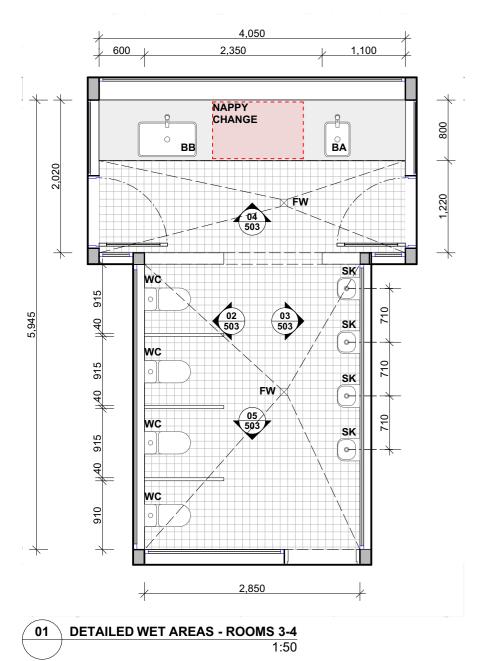

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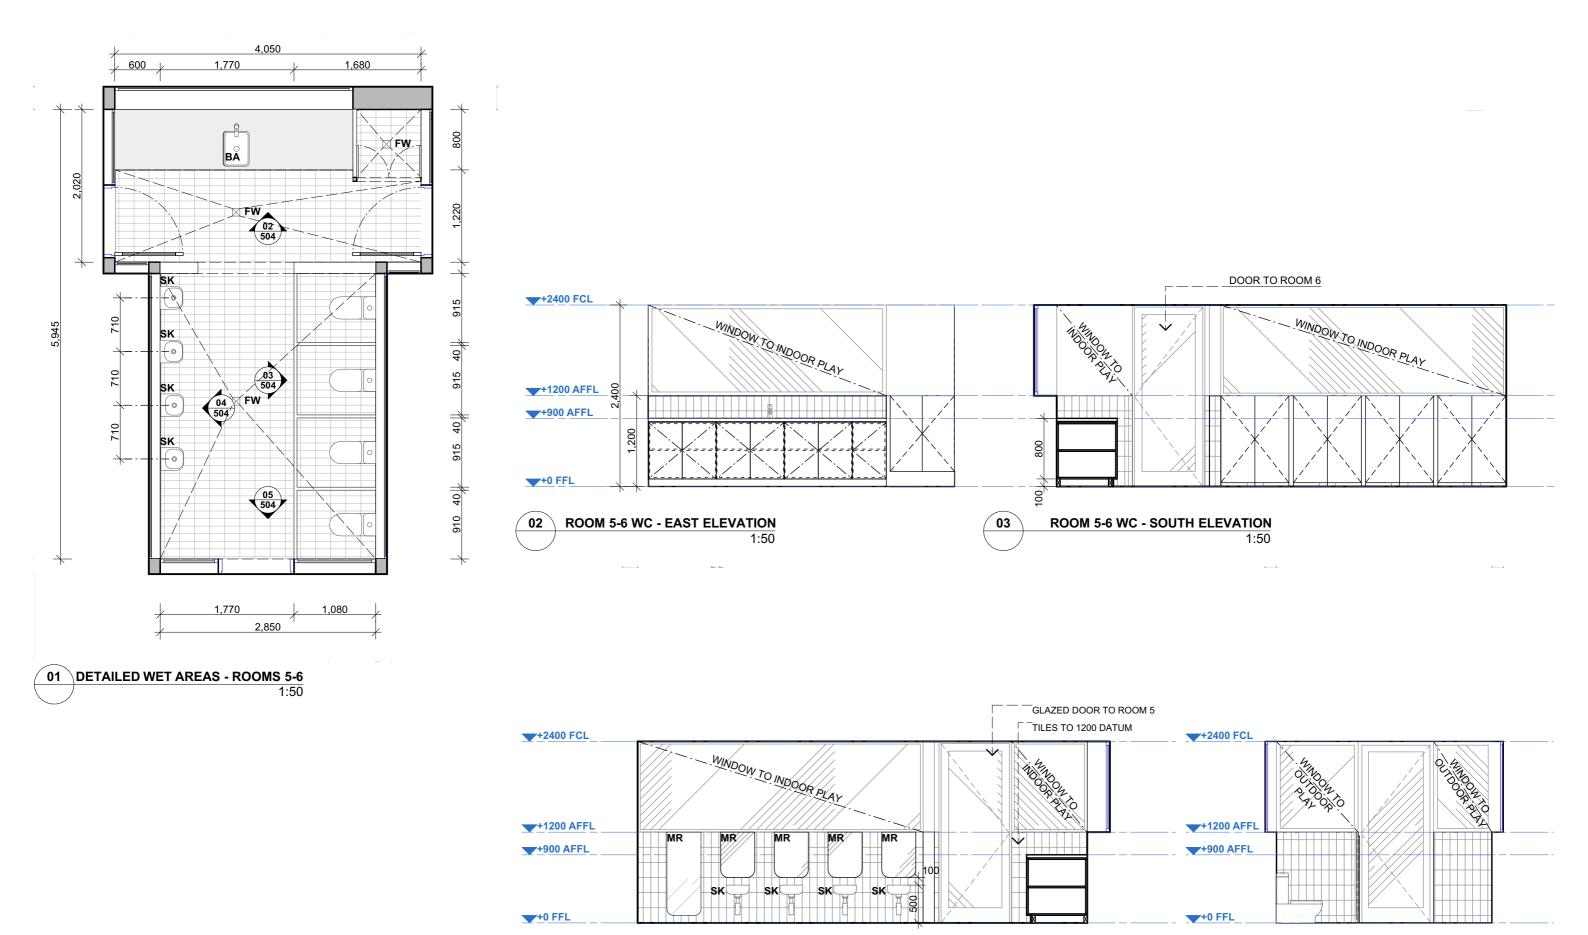
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PROJECT **LEPPINGTON PARK EARLY LEARNING CENTRE**44 PARK ROAD LEPPINGTON NSW 2179, THARAWAL COUNTRY

ROOM 3-4 WET AREAS

DESCRIPTION



ROOM 5-6 WC - NORTH ELEVATION
1:50


ROOM 5-6 WC - WEST ELEVATION
1:50

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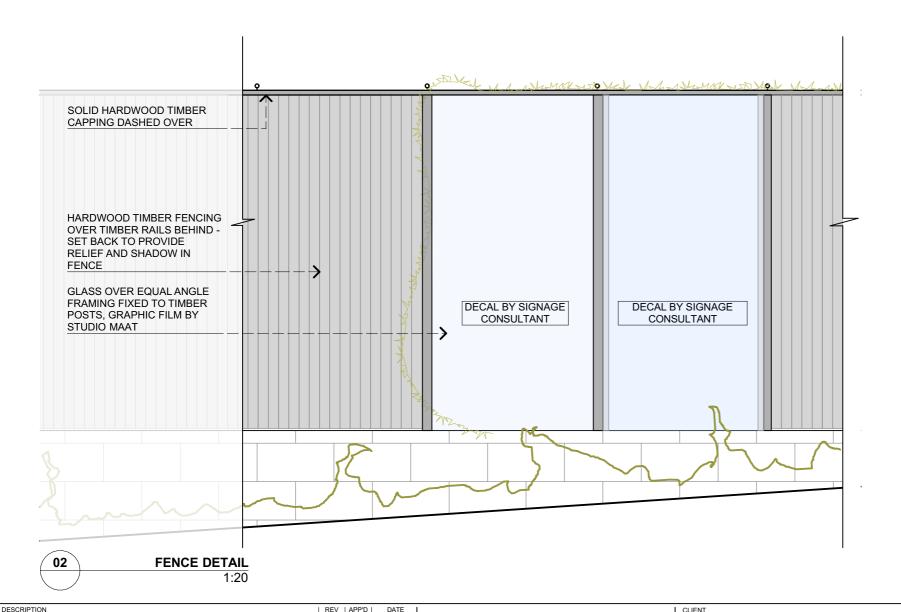
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5-6 WET AREAS

					1101
DESCRIPTION	REV APP	D DATE		CLIENT	SCALE @ A3
REVISED ISSUE FOR DA	A	3/05/2024	samcrawford architects	JECKRA	1:50
REVISED ISSUE FOR DA	В	14/10/2024	Unit 4, 30 Wilson Street, Newtown, Australia NSW 2042		1.50
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REQUIREMENTS TO ARCHITECT BEFORE PROCEEDING.		'		1	



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1:20
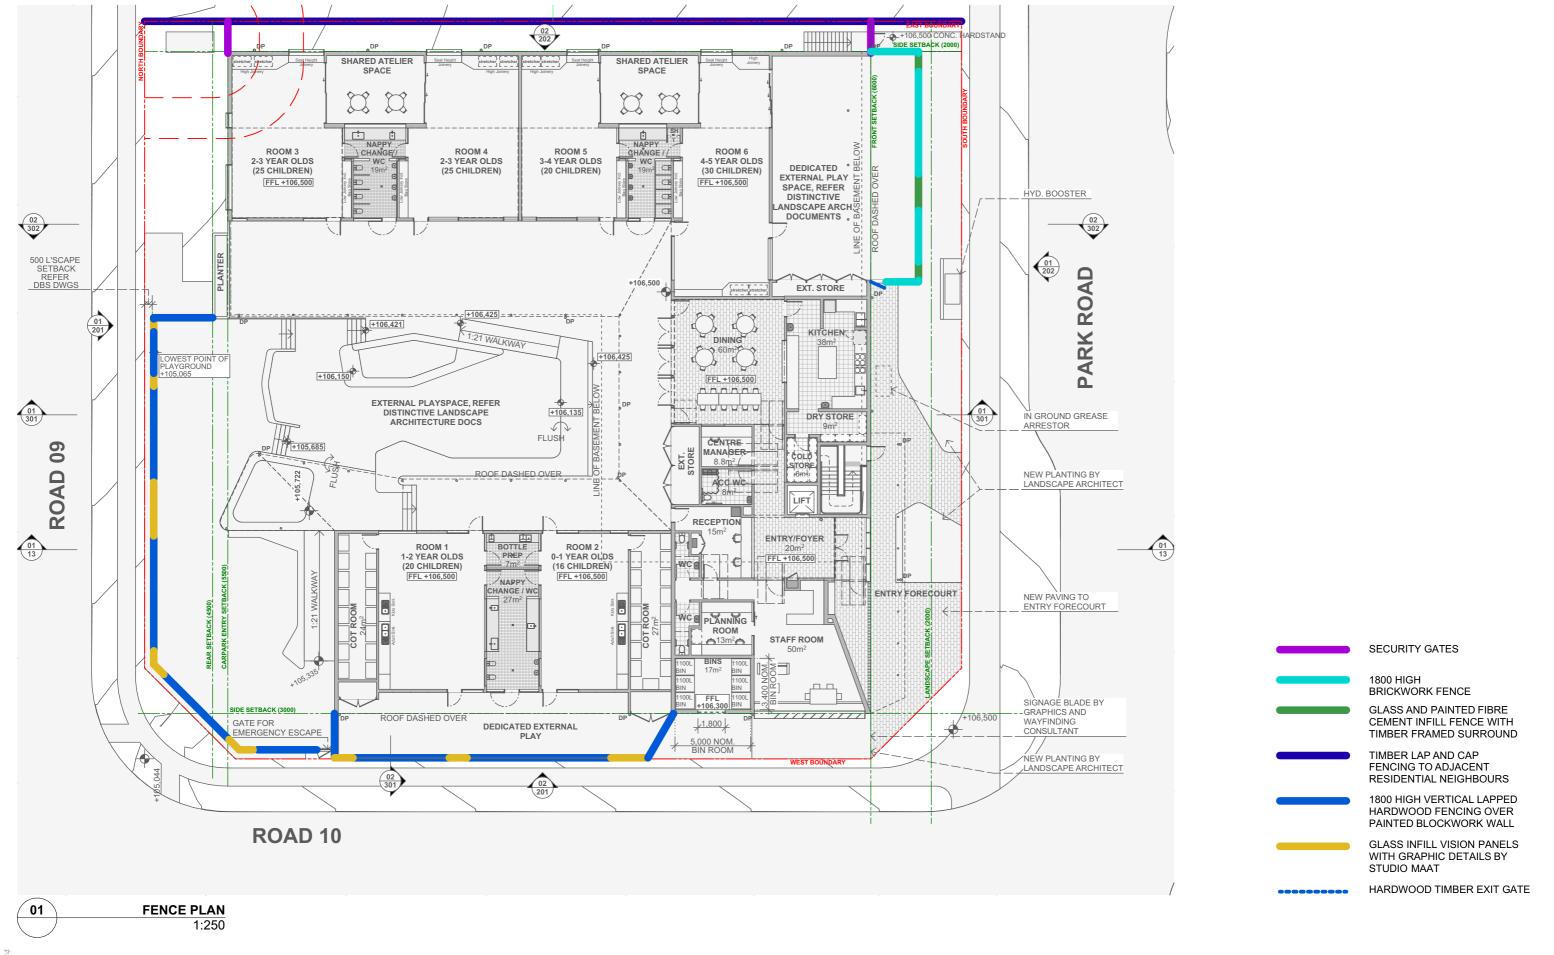
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PROJECT

LEPPINGTON PARK EARLY LEARNING CENTRE
44 PARK ROAD LEPPINGTON NSW 2179, THARAWAL COUNTRY

1:20 | 22.25 | AA | 602

PRAWING TITLE

FENCE DETAILS

PARK ROAD CHILDCARE CENTRE

44 Park Rd, Leppington NSW

Landscape DA

NOVEMBER 2024

REVISION	A B C D	DATE	09.04.24 19.04.24 15.10.24 25.11.24	PREPARED BY	PG/AT PG/AT CX/PG CX/PG	СНЕСКЕД ВУ	MS/DB MS/DB MS/DB MS/DB
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Prepared For:

Jeckra Development

Site Location:

44 Park Rd, Leppington NSW

Prepared By:

distinctive Living Design

Landscape Architecture - Design - Consultancy 56 John St, Camden NSW, Australia 2570 www.distinctive.net.au Ph:02 4655 1881

SHEET REGISTER

DRAWING	TITLE	REVISION
05-24.00	COVERSHEEET	D
05-24.01	CONTENTS	D
05-24.02	MOOD IMAGERY	D
05-24.03	LANDSCAPE MASTER PLAN	D
05-24.04	SHEET DIRECTORY	D
05-24.05	OUTDOOR SPACE CALCULATION	N D
05-24.10	LANDSCAPE DETAIL PLAN 01	D
05-24.11	LANDSCAPE DETAIL PLAN 02	D
06-24.12	PLAY EQUIPMENT DIAGRAM	D
05-24.20	MATERIAL PALETTE	D
05-24.21	LANDSCAPE DETAILS	D


















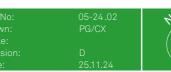









LEGEND

PROPERTY BOUNDARY

SHEET DIRECTORY & MATCHLINE

EXTENT OF BASEMENT

PROPOSED SCREEN PLANTING

RAISED PLANTER BED WALLING
Refer Architecturals

PROPOSED MULCH

SYNTHETIC TURF

LANDSCAPE by other Refer Dangar Barin Smith Landscape Design

PROPOSED WATERPLAY CHANNEL

SOFTFALL RUBBER (LIGHT GREEN)
SOFTFALL RUBBER (DARK GREEN)
SOFTFALL RUBBER (YELLOW)

PROPOSED CONCRETE

PROPOSED HARDWOOD TIMBER DECKING (SPOTTED GUM)

PROPOSED URBAN PAVED AREA Refer Architecturals


PROPOSED BIKE TRACK (COLOURED CONCRETE)

PROPOSED WATERPLAY CHANNEL TAP

PROPOSED TRAMPOLINE (IN-GROUND)


PROPOSED SHADE SAIL

EXTENT OF WORKS

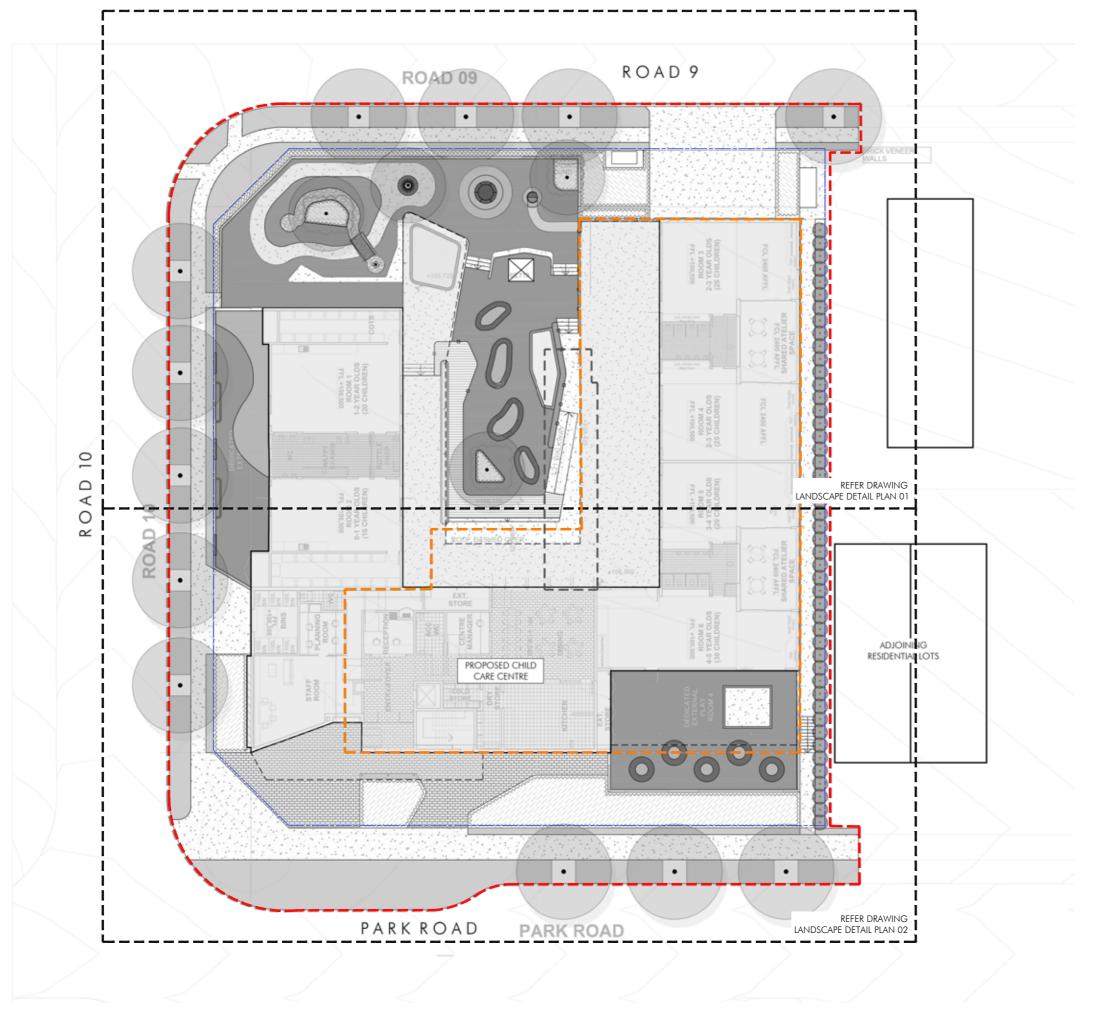





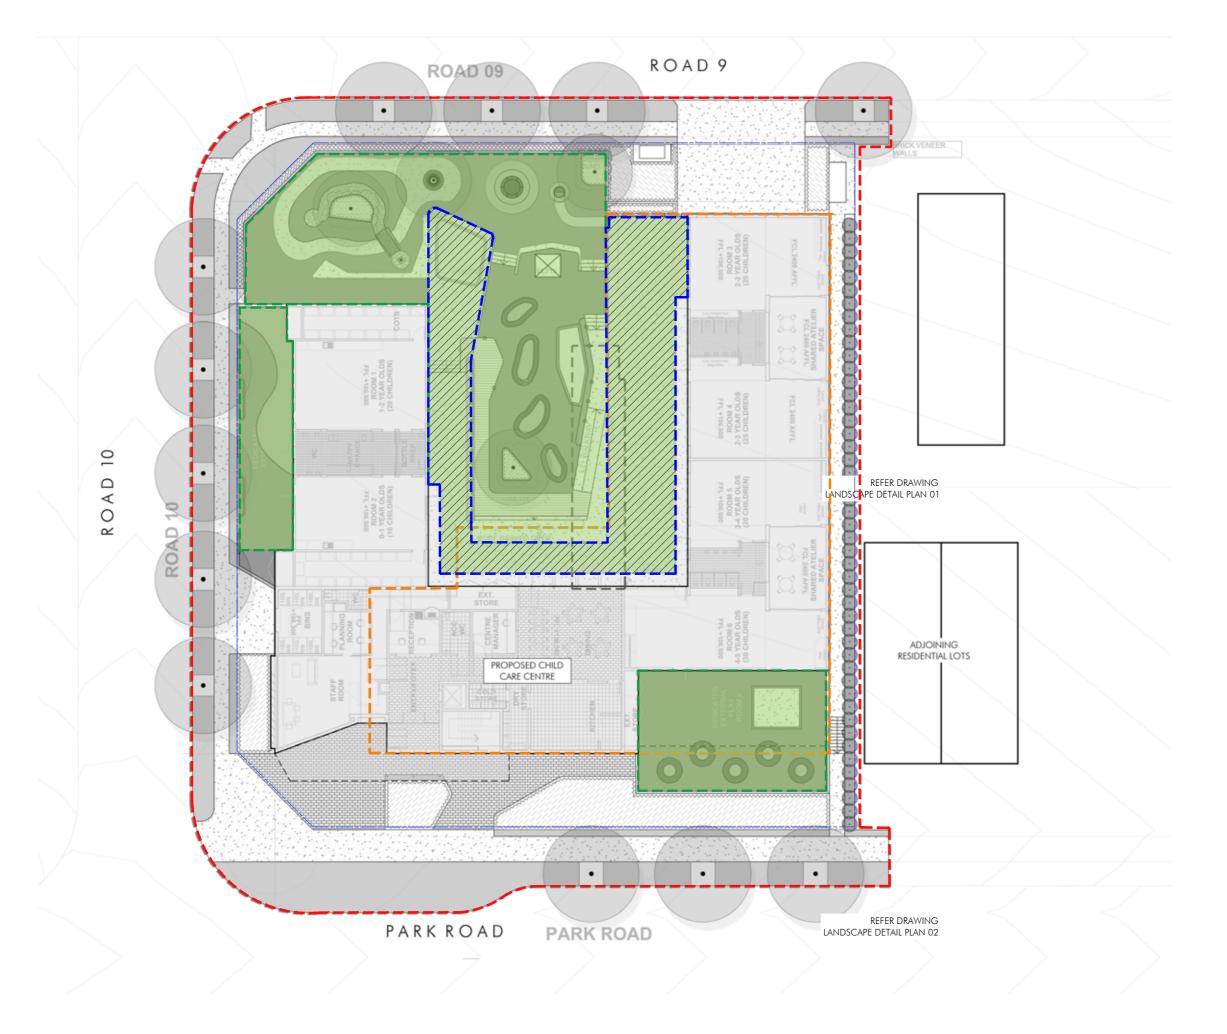





LEGEND

UNENCUMBERED OUTDOOR SPACE
- COVERED OUTDOOR SPACE (284.05 M2)



PARK RD CHILD CARE CENTRE

LANDSCAPE DETAIL PLAN 01

jeckra.

sam crawford architects Job No: 05-24.10
Drawn: PG/CX
Scale: 1:200@A:
Revision: D
Date: 2511.24





PARK RD CHILD CARE CENTRE

LANDSCAPE DETAIL PLAN 02

jeckra.




Job No: Drawn: Scale: Revision: Date:







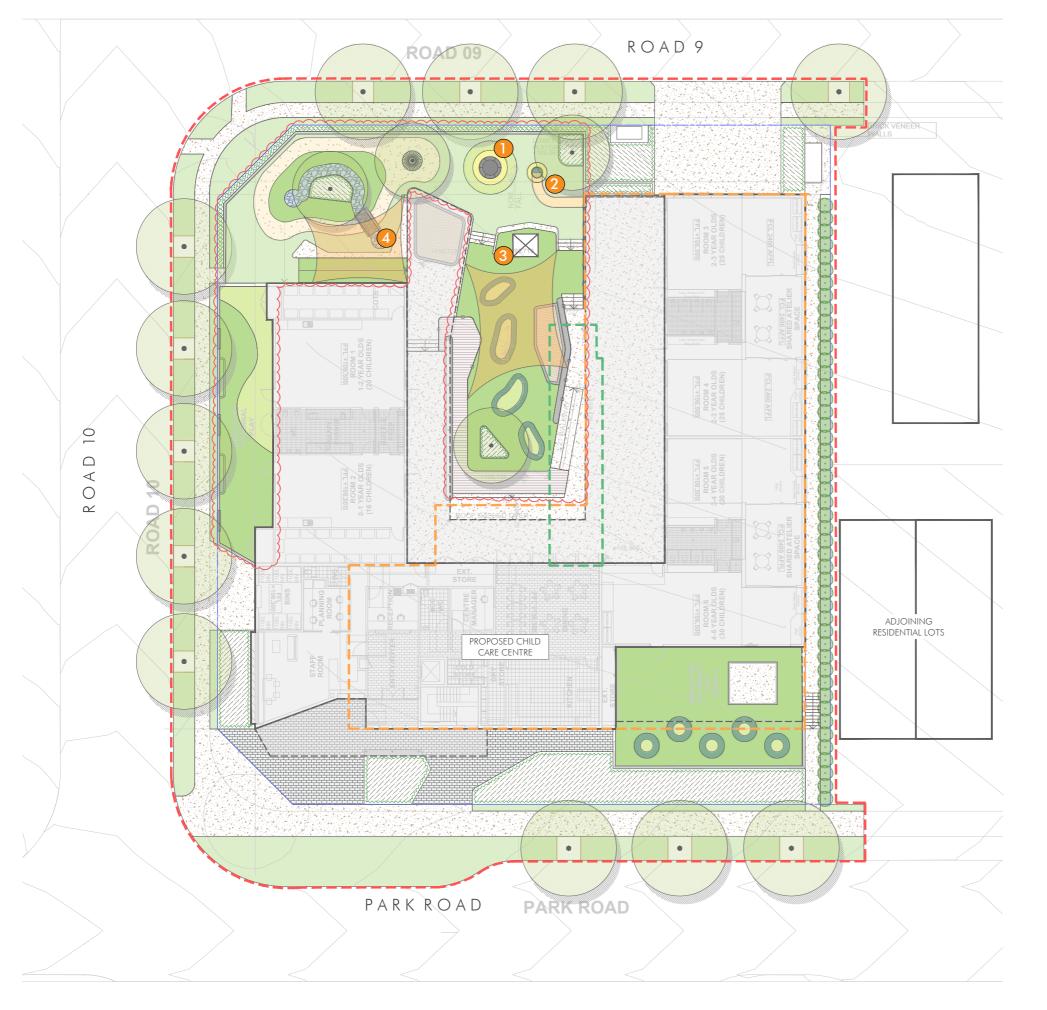




MODUPLAY Joey Trampoline PI - Z-1310 or similar



MODUPLAY Curved Tube Slide - D-8858 or similar

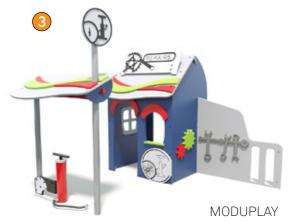


Bike Repair Shop - G-9930 or similar



MODUPLAY Water Pump - WA-9232 or similar






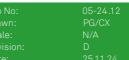



INDICATIVE MATERIALITY



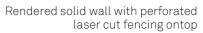

Cubby house/built play area







Water Play rockery channel








Synthetic Turf

Defined contrast between bike track & surrounding play space

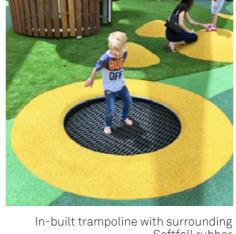

Softfall rubber

TImber Decking - Spotted Gum



Turf



Softfall Rubber

Enclosed slide ncorporated into level change design



Indicative Circular tree grate design within turf & softfall play area



Integrated sand pit design (Refer Architectural Design)

Architect:

crawford

PARK RD CHILD CARE CENTRE






Acacia cognata









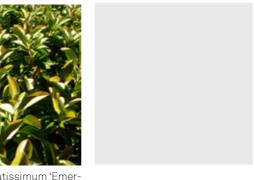





SHRUBS















Viola hederaceae

REFER DANGAR BARIN SMITH LANDSCAPE DESIGN FOR SOFTSCAPE PLANTING DESIGN

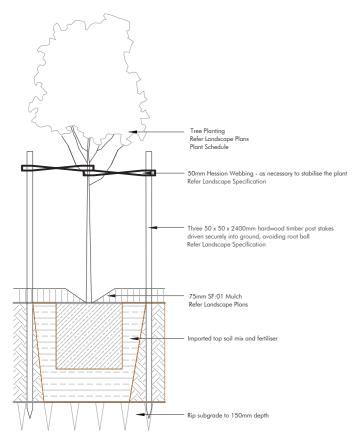

45-100L TREE PLANTING

SECTION 1:10

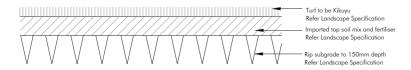

TURF SECTION 1:10

			05-24 P	lant Schedule by distinctive				
Code	Genus	species	Hybrids/Cultivars	Common Name	Pot Size	Height	Width	Spacing
Trees								
Tr Lu	Tristaniopsis	laurina	'Luscious'	Luscious Water Gum	75L	10	7	As Shown
UI am	Ulmus	americana		American Elm	200L	12	8	As Shown
Shrubs/Sci	reen Planting							
Ac Wa	Acacia	cognata	'Waterfall'	Waterfall Wattle	200mm	1.5	1	As shown
Co Ru	Cordyline	terminalis	Rubra'	Cordyline Rubra	200mm	2.5	2.5	As shown
We fr	Westringia	fruticosa	'Grey Box'	Coastal Rosemary	200mm	0.4	0.4	300mm centres
Rh Op	Rhaphiolepis	indica	'Oriental Pearl'	Oriental Pearl Indian Hawthorn	200mm	1	1	2/m2 shown
Vi EL	Viburnum	odoratissimum	Emerald Lustre	Emerald Lustre	300mm	4	4	As shown
Groundco	vers							
Da BM	Dampiera	linearis	Blue Moon'	Blue Dampiera	140mm	0.5	0.6	3/m2
Li RP	Liriope	muscari	'Royal Purple'	LilyTuff	200mm	0.5	0.5	5/m2
Lo LC	Lomandra	confertifolia	'Little Con'	Mat Rush	140mm	0.3	0.3	7/m ²
Му ра	Myoporum	parvifolium		Creeping Boobialla	140mm	0.2	1.5	3/m ²
Op Na	Ophiopogon	japonicus	'Nana'	Dwarf Mondo Grass	140mm	0.1	0.1	12/m2
Tr ja	Trachelospermum	jasminoides		Evergreen Jasmine	200mm	0.3	2.0	2/m ²
Vi he	Viola	hederaceae		Native Violets	140mm	0.1	0.5	5/m ²

GARDEN BEDS

Cultivate to a depth of 200mm so that soil can be worked freely. Apply gypsum at manufacturer's rates to add in de-compaction of site and breokdown of clay colloids. Spread premium blend garden bed mix to a depth of 200mm, when settled. Back filling shall be tampered progressively to match existing soil compaction, to avoid later subsidence. Mound all garden beds to centre. Allow for depth of mulch to finished levels when installing soil mix. Refer to Garden Bed Preparation Detail.

PLANTS

All plants which have been declared, pursuant to section 7 & 8 of the Noxious Weed Act 1993, to be Noxious Weeds within the area of Bankstown City Council shall be removed on site and replaced with appropriate indigenous or native species.

All labels are to remain on plants and delivery receipts or copies of plant purchases, stating the species, amount, and container sizes of plants, shall be made available to Council's Construction Services or Private Certifier to facilitate certification that the landscape plan and conditions of consent have been implemented.

LAWN AREAS

Cultivate to a depth of 150mm, so that soil can be worked freely. Apply Gypsum at manufacturer's rates to add in de-compaction of site and breakdown of clay colloids. Spread 100mm layer of sandy loam topsoil blend. Rake over to form a smooth, even surface ready for lawn installation.

New furt to all reas to be Soft leaf buffalo. Lay with staggered and close-butted joints along contours, to prepared surface. Water immediately, top dress once established.

Refer to Turf detail.

MULCH

Mulch shall be ANL Forest Blend' or similar; which is best suited to the plant type and clients needs. Variation from this can only be made with consultation with the project manager. Mulch shall be free of soil, weed growth or any other foreign matter. Spread mulch evenly to a depth of 75mm over all garden beds. Rake over mulch surface to create an even finish.

IRRIGATION SYSTEM

An irrigation system is to be installed to all garden beds, planter boxes, and turf areas shown on the landscape plans. Drip systems are recommended for all garden beds and planter boxes, and pop-up systems for turf areas to the manufactures guidelines. Water connection to mains and requirements for metering are to be installed by a licensed plumber or qualified irrigation contractor.

MAINTENANCE SCHEDULE

Routine Maintenance. Provide routine maintenance for a period of six months after practical completion. Program to include but not limited to plant establishment, watering, mowing, fertilising, weeding, staking , pruning, mulching, pest and disease control and generally maintaining the site in a neat and tidy condition.

Watering: Watering of plants and turf should be done in conjunction with current Sydney Water watering restrictions.

Fertilising. Apply an appropriate lawn fertiliser, at manufacturer's rates, after 6 weeks of installation. Ensure fertiliser is adequately watered and evenly dispersed for healthy even lawn arowth.

Mulch of garden beds must adhere to Australian Standa

Lawns. Repair lawns in all failed areas.

Disease and Pest Control. If pathological disease or insect pests appear, they are to be controlled using organic methods or pest and disease control. Failing this, chemical sprays may be used, at manufacturer's rates, with prior consent of client.

Replacement. Defects including any dead or unhealthy plant must be replaced or treated within 3 weeks. Missing, dead or unhealthy plants are to replaced with plants of similar size and quality and identical species/variety, unless a substitution has been approved by Council.

Any Pruning must be carried out to meet Australian Standards AS4373 'Pruning of Amenity Trees' and shall comply with Councils Tree Preservation Order.

Making Good. The contractor shall make good erosion of soil












Futuro Leppington Park External Signage Design Drawings

Issue for DA 23.04.24

Brand palette

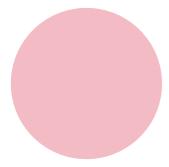


Futuro Pink

PMS 495 C C2 M31 Y10 K0 Dulux Feather Boa S02G1




Futuro Blue

PMS 279 C C72 M37 Y0 K0 Dulux Window Blue SB8E3

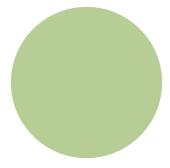

Futuro Green

PMS 578 C C31 M7 Y51 K0 Dulux Sour Apple S20F4

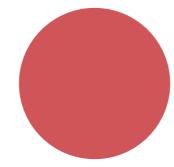


Futuro Red

PMS 7418 C C14 M81 Y61 K1 Dulux Oxford Terrace NZ10E6 Dulux Swedish Yellow S16H4




Futuro Yellow

PMS 1205 C C3 M10 Y53 K0

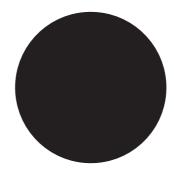

Black


PMS Black U C20 M20 Y20 K100 Dulux PG1A9

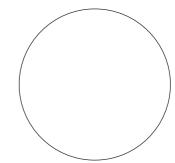

White


PMS White C0 M0 Y0 K0 Dulux Vivid White

Statutary & Operational palette

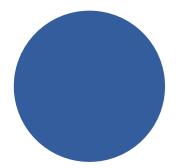

Access Blue

PMS 7684C C87 M68 Y9 K1

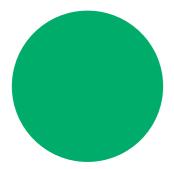

Exit Green

PMS 3405C C100 M0 Y83 K0 Dulux G12 Holly1



Hazard Yellow

PMS 122U C0 M29 Y100 K0 Dulux PMS123U



Fire Red **Danger Red**

PMS 485C C0 M95 Y100 K0 Dulux Red Clown P05H8





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Issue

DA

Issue for

A 04.04.24 Issue for Review B 18.04.24 Issue for Review C 23.04.24 Issue for DA

Revisions

Project no. JEK2402

Drawing

Palette

Date 27.03.24

Futuro

Park

Leppington

Project

BA/JM

Signtype

Drawn/Checked Drawing number JEK2163-GEN-003

> Revision C



ABCDEFGHIJKLMNOPQRSTUVWXYZ abcdefghijklmnopqrstuvwxyz 1234567890

Wayfinding typeface Calibre Medium

Childcare

Typical application Title case Cap height: 30mm Scale 1:1

Female

Tactile typeface Arial, Bold Cap height: 15mm Scale 1:1





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Issue Issue for DA

A 04.04.24 Issue for Review B 18.04.24 Issue for Review C 23.04.24 Issue for DA

Project no. JEK2402

Drawing

Typeface

27.03.24

Project

Park

Futuro

Leppington

BA/JM

Signtype

Drawn/Checked

JEK2163-GEN-004




LEPPINGTON

02 Type detail Leppington Park 50mm cap height Scale 1:5

Child

03 Type detail Childcare & Education 80mm cap height Scale 1:5



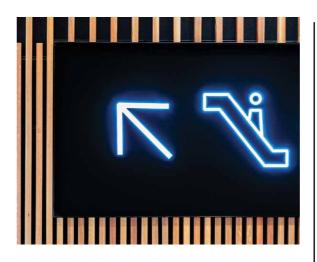

05 Reference Intracut rear-illuminated graphics



GENERAL

The sign is located on the primary vehicular roadway adjoining the site boundary, in soft landscaping, to identify the facility, and confirm the vehicular entry/parking is at the rear of the site. The signs/graphics are located in a public environment, as such all materials, fabrication and fixing to suit expected conditions. Sign form is accessible to the public.

FRANGIBI F

The Signage contractor is responsible for determining, following consultation with the local authority and relevant codes/standards if the signage adjacent the roadway is required to be frangible.

If required shopdrawings are to be prepared by an approved Chartered Professional Engineer specialising in Structural Engineering, on the Signage Contractors behalf, prior to manufacture, shall be fully detailed and shall show the proposed means of strengthening the sign face and achieving post frangibility.

Where a frangible support cannot be provided, details for a proposed alternative arrangement are to be submitted for approval. The cost of these drawings, calculations and submission will be borne by the signage contractor.

MATERIALITY

Fabricated structural steel 'C' sections, exposed vertical sides and top, fully welded up, with internal framing to form a water proof enclosure. Below ground concrete footing with fabricated 3mm painted as illustrated metal sign panels attached via concealed countersunk fixing. To be co-ordinated with landscape works, make good any damage to existing ground plane/landscape surfaces. Top section to be internally illuminated graphics to be rear illuminated intracut acrylic letters. Non-illunimated letters/graphics to lower section to be external grade cast vinyl solid colour film graphics applied to sign panel with clear overcoat. To be satin finish.

NOTES (cont.)

FINISHES/COLOUR As illustrated. For colour specification refer Graphic standards

To be external grade paint system. Anti-graffiti satin finish 25% gloss level to all exposed surfaces.

LOCATING PRINCIPLES As noted on masterplan. Final setout TBD, to be coordinated with landscape works.

CONTENT

As documented

FABRICATION


'C' sections to form up external frame & cladding. To be in whole pieces along each run. All joints at corners to be neatly welded and mitred, to be continuous, grind smooth and flush all surfaces. To be galvanised and painted structural steel 'C sections with galvanised base plate/mechanical fixing to below ground footing.

Footings concealed below ground as requried and certified by structural engineer to ensure secure fixing and to maintain the sign upright in expected conditions.

Refer FRANGIBLE note

Sign panels to be fabricated 3mm painted metal sign panels attached via concealed countersunk fixing laser cut to form illustrated. All edges to be smoothed, slightly rounded to ensure no sharp edges. To be painted on all exposed surfaces.

Panels to be whole pieces fabricated as per illustrations adjacent. Welded mitred joints to be continuous, grind smooth and flush all surfaces. All edges to be smoothed, slightly rounded to ensure no sharp edges. Attach sign panels to structural posts and sub-frame as required to ensure permanent secure fixing. Base of totem to have marine grade backing to provide robust low level surface.

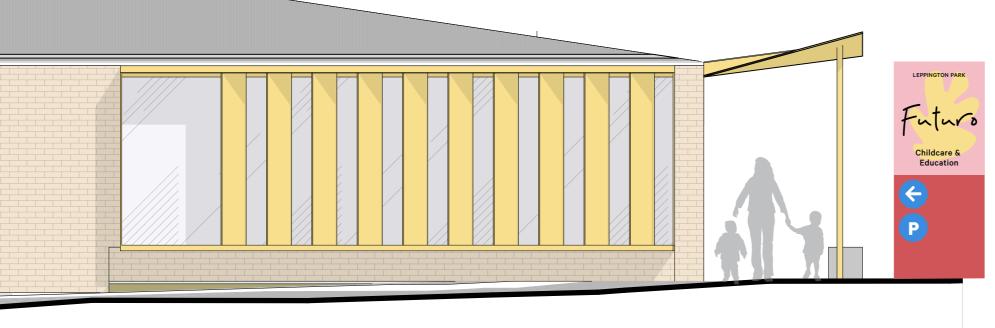

01 Part elevation Road 09 Scale 1:50





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Issue Issue for DA

Revisions

A 04.04.24 Issue for Review B 18.04.24 Issue for Review C 23.04.24 Issue for DA

Project no. JEK2402

Drawing Site vehicular directional

Date 27.03.24

Futuro

Park

Leppington

Project

Signtype D.2

BA/JM

Drawn/Checked

Drawing number JEK2402-D2-001





NOTES (cont.)

FIXING

Circular countersunk mechanical fixings to internal face via tabs, with separation between metals as required. Layout of fixins to be at regular intervals, not visible on front face to be determined during shopdrawings phase. All exposed surfaces o be painted.

GRAPHICS

Illuminated graphics to be rear illuminated intracut acrylic letters/graphic, refer below. Acrylic to appear black during the day and glow white at night.

Non-illunimated letters/graphics to be external grade cast vinyl solid colour film, Premium Cast Avery or similar equivalent, vinyl installed to manufacturers specifications. All lettering/forms shall be sharp and true to the selected typeface and artwork. Pre-spaced and electronically cut vinyl film, ensure cut edges are not overheated and are cut slowly to achieve a clean cut. Clear satin overcoat to all surfaces.

ILLUMINATION

Fabricated internally illuminated letters/graphic intracut into sign panel front and rear face of pylon. Front face of letters to align with face of sign panel. Bright warm white LED units located behind letters concealed in internal totem void. All conduits/power source to be concealed in totem. Power to be supplied to totem location by others. Ensure no light leakage. Top panel to be removeable, via concealed mechanical fixings to service LED unit, location/size and fixing to be determined during shopdrawing

Isolating switch to signform to be remote to signform in waterproof box in landscape adjacent provided by signage contractor, OR within adjacent building. Final location to be determined during shopdrawing phase with client. Housing to be painted green to conceal unit in planting, or as per adjacent wall finish if located within building.

 $M \rightarrow$

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Issue Issue for DA

Revisions

A 04.04.24 Issue for Review B 18.04.24 Issue for Review C 23.04.24 Issue for DA

Project no. JEK2402

Drawing Site vehicular directional

27.03.24 Project

Leppington

Futuro

Park

BA/JM Signtype D.2

Drawn/Checked

JEK2275L-D2-002





02 Reference Pin-fixed, halo-lit letters



Futuro

NOTES

GENERAL

The sign is located on the building facade visible to vehicular & pedestrian traffic, illustrating the destination name for day and nighttime viewing. The sign/logo is located in an external environment, as such all materials, fabrication and fixing to suit expected conditions.

MATERIAI ITY

'Futuro' to be fabricated metal internal framing pinned off wall, clad by painted fabricated letters, with recessed/concealed continuous LED halo lighting, & opal acrylic back-panel, to provide a soft even glow onto the facade. All metal elements to be painted to match.

FABRICATION

Shopdrawings are to be prepared by an approved Chartered Professional Engineer specialising in Structural Engineering, on the Signage Contractors behalf.

The cost of these structural drawings/calculations, will be borne by the signage contractor.

'Futuro' letter elements to be fabricated as individual forms, no joints, to be min fabricated 2mm metal panels, or as required to ensure structural integrity, water jet cut to logo illustrated. Front elevation and sides to be in whole pieces. All joints at edges to be welded and mitred, to be continuous, grind smooth and flush all surfaces. All edges to be smoothed, slightly rounded to ensure no sharp edges. Internal structural framing to suit logo and lighting requirements, ie no shadows to lighting. Back-panel to be opal acrylic, hairline butt joint materials, and align flush with metal sides. Overall depth of letters to be 100mm or as required by lighting, fabricate logo form as integral waterproof element, with separation between metals as required, rear concealed pin fix at regular spacing to facade.

 $M \rightarrow$

Scale 1:100

01 Part NE elevation Road 09

▼ T

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Issue Issue for DA

Revisions

A 04.04.24 Issue for Review B 18.04.24 Issue for Review C 23.04.24 Issue for DA

Project no. JEK2402

Drawing

Primary

Building ID

Date 27.03.24

Leppington

Futuro

Park

Project

Drawn/Checked BA/JM Signtype

Drawing number JEK2402-I1-001



NOTES (cont.)

All individual fabricated letters should be fabricated in one piece. Radius all edges 3mm. Setout via pre-spaced and electronically cut vinyl film. Ensure all corners/edges are sharp and true to the artwork. Ensure cut edges are not overheated and are cut slowly to achieve a clean cut.

FIXING

'Futuro' to be fixed via painted metal pins fixed to facade and internal frame spaced off to create halo lighting. Conduit concealed within individual pin fixings and logo and via painted individual conduits through facade penetration. Distance off facade as required for halo lighting with good spread of light onto surface. Logo width as indicated, to be developed in shopdrawing phase.

FINISHES/COLOUR

To be DULUX 2-pak paint external grade paint system. Colour: Black

For colour specification refer Graphic standards

Anti-graffiti satin finish 25% gloss level to all exposed surfaces

ILLUMINATION

Bright warm white LED units located within logo form, to create rear halo lighting through white acrylic backing. Light output to be even across logo form, no hot spots to create an even glow around form. To have dimmer control to adjust light output and be linked to building operating systems to allow timer control/switch off.

All power/control systems to be run through rear. LED transformers etc to be housed internally in an accessible space. To be determined during shopdrawing phase with client.

LOCATING PRINCIPLES As noted on elevation and setout notes.

GRAPHICS

Fabricated metal & acrylic logo, true to supplied artwork, halo lit, with painted non-illuminated acrylic letters.

CONTENT As noted.

 $M \rightarrow$

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Issue Issue for DA

Revisions

A 04.04.24 Issue for Review B 18.04.24 Issue for Review C 23.04.24 Issue for DA

Project no. JEK2402

Drawing Primary

Building ID

Date 27.03.24

Futuro

Park

Project


Leppington

BA/JM Signtype

Drawing number JEK2402-I1-002 Drawn/Checked



02 ReferencePin-fixed, halo-lit letters

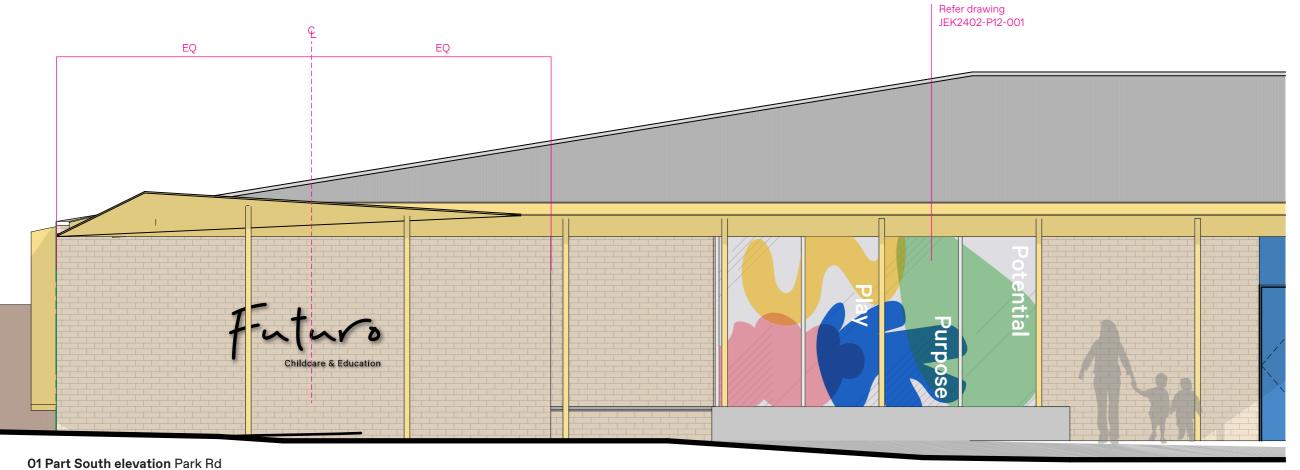

Scale 1:50

M >

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Issue Issue for DA Revisions
A 04.04.24 Issue for Review
B 18.04.24 Issue for Poview

B 18.04.24 Issue for Review C 23.04.24 Issue for DA

Project no. JEK2402

Pedestrian entry

Drawing
Secondary
Building ID

27.03.24
Project

Futuro

Park

Leppington

Drawn/Checked BA/JM Signtype I.2.1 Drawing number **JEK2402-121-001**

Revision **C**

letters.

NOTES GENERAL

MATERIALITY

masonry wall. FABRICATION

Contractors behalf.

The cost of these structural

the signage contractor. 'Futuro' letter elements to be fabricated as individual forms, no joints, to be min fabricated 2mm metal panels, or as required to ensure structural integrity, water jet cut to logo illustrated. Front elevation and sides to be in whole pieces. All joints at edges to be welded and mitred, to be continuous, grind smooth and flush all surfaces. All edges to be smoothed, slightly rounded to ensure no sharp edges. Internal structural framing to suit logo and lighting requirements, ie no shadows to lighting. Back-panel to be 20mm white acrylic, hairline butt joint materials, and align flush with metal sides. Overall depth of letters to be 40mm or as required by lighting, fabricate logo form as integral waterproof element, with separation between metals as required, rear concealed pin fix at regular spacing to

The sign is located at low level on a masonry landscape wall at the entry to the facility, illustrating the destination

name for day and nighttime viewing. The sign/logo is located in an external public environment accessible to the public from the adjacent ground level, as such all materials, fabrication and fixing to suit expected conditions.

'Futuro' to be fabricated metal painted letters with internal framing pinned off facade, with recessed/concealed continuous LED halo lighting, & 20mm white acrylic back-panel, to provide a

soft even glow onto the facade. All


Shopdrawings are to be prepared by an approved Chartered Professional Engineer specialising in Structural Engineering, on the Signage


drawings/calculations, will be borne by

metal elements to be painted to match 'Childcare & Education' to be 4mm painted solid acrylic sheet laser cut letters conceal adhesive fix to the

'Childcare & Education' text to be 4mm solid acrylic sheet laser cut



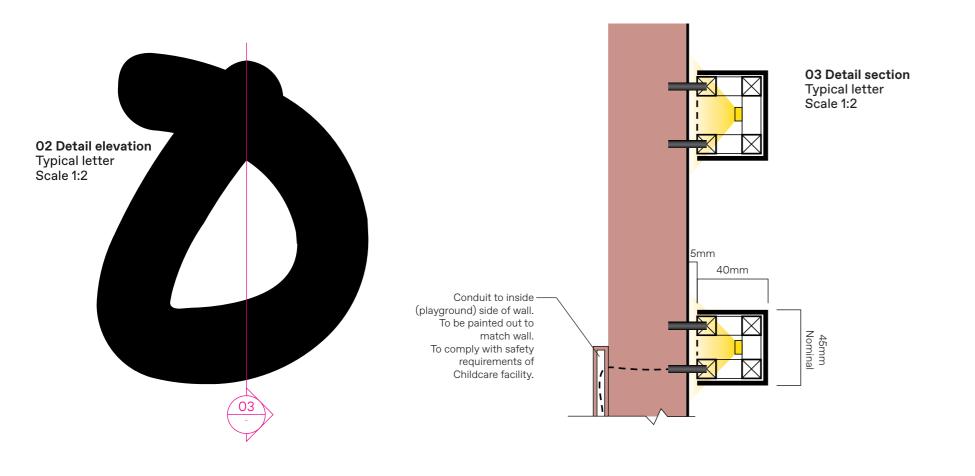

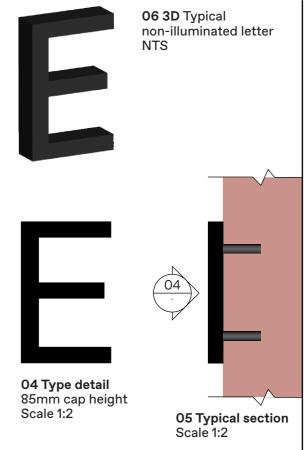

overheated and are cut slowly to achieve a clean cut. **FIXING** 'Futuro' to be fixed via painted metal pins fixed to wall and internal frame spaced off to create halo lighting. Conduit concealed within individual pin fixings and logo and via painted individual conduits through wall penetration. Distance off wall as required for halo lighting with good spread of light onto surface. Logo width as indicated, to be developed in shopdrawing phase. 'Childcare & Education' fabricated letters to be permanent conceal adhesive fix to base building wall

All edges to be smoothed, slightly rounded to ensure no sharp edges. To be

painted on all exposed surfaces. All

3mm. Setout via pre-spaced and electronically cut vinyl film. Ensure all corners/edges are sharp and true to the

artwork. Ensure cut edges are not

individual fabricated letters should be

fabricated in one piece. Radius all edges

surface via Soudal Fixall adhesive silicone or similar equivalent. Utilise suitable adhesive for fixing surfaces/finishes, prepared and installed to manufacturers specifications to ensure permanent secure fixing.

FINISHES/COLOUR

To be DULUX 2-pak paint external grade paint system. Text content to be Black or White - to be determined by client in relation to brick colour. Anti-graffiti satin finish 25% gloss level to all exposed surfaces

ILLUMINATION

Bright warm white LED units located within logo form, to create rear halo lighting through white acrylic backing. Light output to be even across logo form, no hot spots to create an even glow around form. To have dimmer control to adjust light output and be linked to building operating systems to allow timer control/switch off.

All power/control systems to be run through rear. LED transformers etc to be housed internally in an adjacent accessible space. To be determined on site with client.

LOCATING PRINCIPLES

Similar to as noted on elevation. To be confirmed onsite with client & architect.

GRAPHICS

Fabricated metal & acrylic logo, true to supplied artwork, halo lit, with painted non-illuminated acrylic letters.



2,000mm Nominal



M >

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01 Elevation

NTS

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Joanna Mackenzie ioanna@studiomaat.com.au Bridget Atkinson bridget@studiomaat.com.au As shown at A3

Issue Issue for DA

A 04.04.24 Issue for Review B 18.04.24 Issue for Review C 23.04.24 Issue for DA

Project no. JEK2402

Drawing Secondary **Building ID** Pedestrian entry 27.03.24

07 3D

Typical letter

Project **Futuro** Leppington Park

Drawn/Checked BA/JM

1.2.1

Signtype


JEK2402-I21-002



03 Reference Vinyl to glazing



Refer drawing JEK2402-01-002

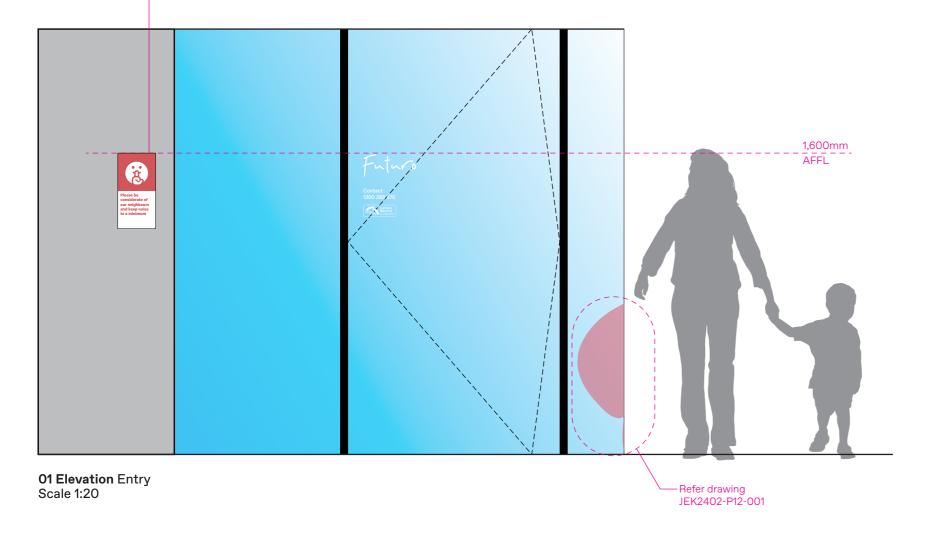

Contact 1300 388 876



02 Detail Indicative messaging Scale 1:5

NOTES

GENERAL

The signs/graphics are located at the entry to the facility to confirm the name of destination at the primary entry to the facility; and to provide operational information to visitors, including opening hours and contact details.

The signs/graphics s are located in a public environment, as such all materials, fabrication and fixing to suit expected conditions.

MATERIALITY

To be external grade cast vinyl solid colour film, Premium Cast Avery vinyl installed to manufacturers specifications. To be satin finish.

FABRICATION

Pre-spaced and electronically cut vinyl film. Sign content to be weeded out of vinyl. Ensure all corners/edges are sharp and true to the artwork.

Ensure cut edges are not overheated and are cut slowly to achieve a clean cut.

FINISHES/COLOUR

To be White, Colour as illustrated

For colour specification refer Graphic standards

GRAPHICS

All lettering/forms shall be sharp and true to the selected typeface.

LOCATING PRINCIPLES To be applied to internal face of

glazing such that content is legible/read from outside.

As noted on elevation and setout

Final setout to be reviewed and agreed on site with client.

CONTENT As documented

I.3

0.3.1

 $M \rightarrow$

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Joanna Mackenzie joanna@studiomaat.com.au Bridget Atkinson bridget@studiomaat.com.au Scale As shown at A3

Issue Issue for DA

Revisions

A 04.04.24 Issue for Review B 18.04.24 Issue for Review C 23.04.24 Issue for DA

Project no. JEK2402

Drawing Facility ID, Entry

Date 27.03.24

Project

Park

Futuro

Leppington

Drawn/Checked BA/JM

Signtype

1.3

Drawing number JEK2402-I3-001


1,750mm **LEPPINGTON PARK** 06 Detail elevation Identification panel Scale 1:20

Childcare

04 Type detail Childcare & Education 55mm cap height Scale 1:5

LEPPINGTON

05 Type detail LEPPINGTON PARK 55mm cap height Scale 1:5

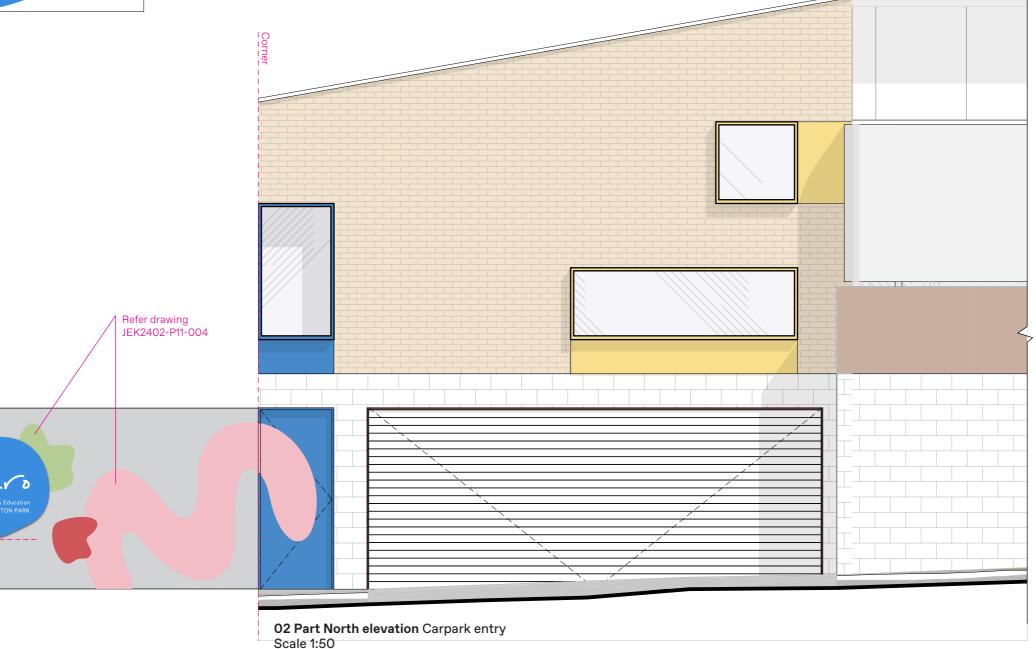

NOTES

GENERAL

The signs/graphics are located to provide operational information to arriving/departing visitors, including speed recommendations. The signs/graphics are located in an external/internal public environment, as such all materials, fabrication and fixing to suit expected conditions.

MATERIALITY

2/3mm painted Aluminium sign panel with external grade cast vinyl solid colour film graphics applied to sign panel with clear overcoat. To be satin finish.

FABRICATION

Fabricated sign panel as per illustrations adjacent, to be one piece, no joints. Final thickness of panel to ensure panel remains flat and even. no warping or slumping. All edges to be smoothed slightly rounded to ensure no sharp edges. To be painted on all exposed surfaces.

Permanent conceal mechanial & adhesive fix panel to base building wall surface via Soudal Fixall adhesive silicone or similar equivalent. Utilise suitable adhesive for fixing surfaces/finishes, prepared and installed to manufacturers specifications.

FINISHES/COLOUR

As illustrated. For colour specification refer Graphic standards

To be two pack polyurethane, external grade paint system.

Anti-graffiti satin finish 25% gloss level to all exposed surfaces.

GRAPHICS

Graphics to be external grade cast vinyl solid colour film, Premium Cast Avery or similar equivalent, vinyl installed to manufacturers specifications. All lettering/forms shall be sharp and true to the selected typeface and artwork. Pre-spaced and electronically cut vinyl film, ensure cut edges are not overheated and are cut slowly to achieve a clean cut.

LOCATING PRINCIPLES

As noted on elevation and setout notes. Final setout to be reviewed and agreed on site with client.

CONTENT

As documented



Scale 1:50



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475mm

AFFL

01 Part West elevation Carpark entry

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Issue Issue for DA

A 04.04.24 Issue for Review B 18.04.24 Issue for Review C 23.04.24 Issue for DA

Project no.

Carpark

Entry ID

JEK2402 Drawing

Project

Futuro

Park

27.03.24

Leppington

BA/JM Signtype


1.4.2

Drawing number **JEK2402-I42-001** Drawn/Checked



24 hour CCTV

03 Type detail 20mm cap height Scale 1:1

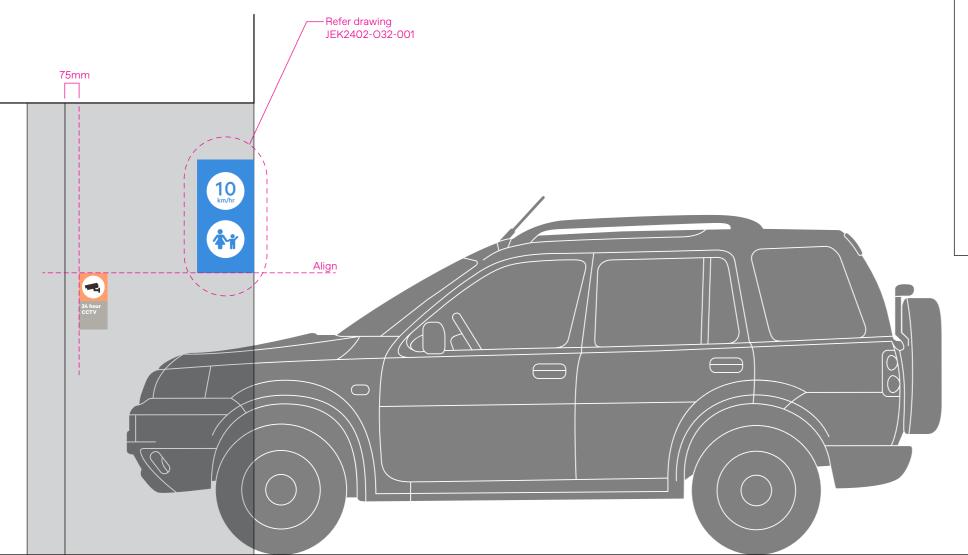

24 hour **CCTV** 02 Elevation CCTV

01 Part section Driveway Scale 1:20

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Issue Issue for DA

A 04.04.24 Issue for Review B 18.04.24 Issue for Review C 23.04.24 Issue for DA

Project no. JEK2402

Drawing Operational T&Cs

Scale 1:2

27.03.24

Leppington

Project **Futuro**

Park

BA/JM Signtype

Drawn/Checked

Drawing number **JEK2402-01-001**

achieve a clean cut. LOCATING PRINCIPLES

Revision C

& Client. CONTENT

As documented

Notes **GENERAL**

The signs/graphics are located in

environment, as such all materials, fabrication and fixing to suit

2mm painted Aluminium sign panel with external grade cast vinyl solid

colour film graphics applied to sign panel with clear overcoat. To be

Fabricated sign panel as per illustrations adjacent. All edges to

ensure no sharp edges. To be

be smoothed slightly rounded to

painted on all exposed surfaces.

Permanent conceal adhesive fix

panel to base building wall/door surface via Soudal Fixall adhesive

suitable adhesive for fixing surfaces/finishes, prepared and

installed to manufacturers

To be two pack polyurethane, external grade paint system.

Anti-graffiti satin finish 25% gloss level to all exposed surfaces.

Graphics to be external grade cast

vinyl solid colour film, Premium

Cast Avery or similar equivalent,

vinyl installed to manufacturers specifications. All lettering/forms shall be sharp and true to the selected typeface and artwork. Pre-spaced and electronically cut vinyl film, ensure cut edges are not overheated and are cut slowly to

Setout tbd in relation to adjacent sign panel/s. Similar to as noted on elevation and setout notes, except where documented by MAAT on other drawings in this pack.

To be finalised onsite with Architect

specifications.

standards

FINISHES/COLOUR As illustrated. For colour specification refer Graphic

silicone or similar equivalent. Utilise

external/internal public


expected conditions.


MATERIALITY

satin finish. **FABRICATION**

Please be considerate

03 Type detail 15mm cap height Scale 1:1

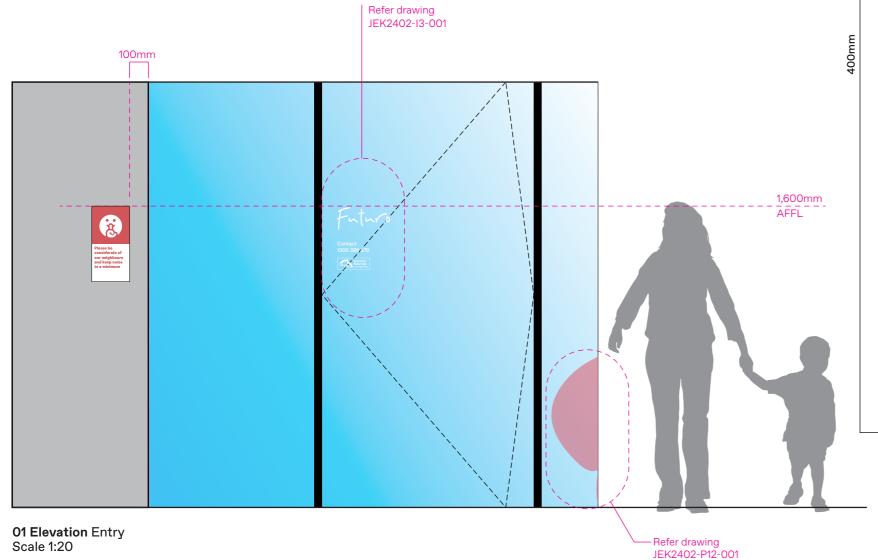

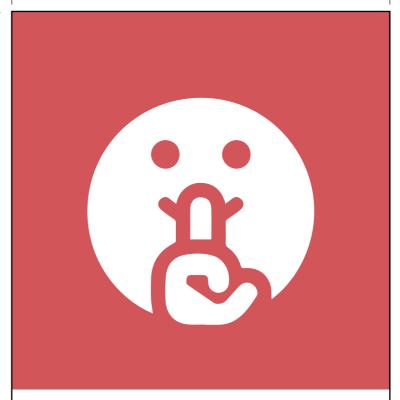

Please be considerate of our neighbours and keep noise to a minimum

02 Elevation Noise advisory Scale 1:2

Notes

GENERAL

The signs/graphics are located in external public environment, as such all materials, fabrication and fixing to suit expected conditions.

MATERIALITY

2mm painted Aluminium sign panel with external grade cast vinyl solid colour film graphics applied to sign panel with clear overcoat. To be satin finish.

FABRICATION

Fabricated sign panel as per illustrations adjacent. All edges to be smoothed slightly rounded to ensure no sharp edges. To be painted on all exposed surfaces.

FIXING

Permanent conceal adhesive fix panel to base building wall/door surface via Soudal Fixall adhesive silicone or similar equivalent. Utilise suitable adhesive for fixing surfaces/finishes, prepared and installed to manufacturers specifications.

FINISHES/COLOUR As illustrated. For colour specification refer Graphic standards

To be two pack polyurethane, external grade paint system.

Anti-graffiti satin finish 25% gloss level to all exposed surfaces.

GRAPHICS

Graphics to be external grade cast vinvl solid colour film. Premium Cast Avery or similar equivalent, vinyl installed to manufacturers specifications. All lettering/forms shall be sharp and true to the selected typeface and artwork. Pre-spaced and electronically cut vinyl film, ensure cut edges are not overheated and are cut slowly to achieve a clean cut.

LOCATING PRINCIPLES As noted on elevation and setout

CONTENT As documented

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Issue Issue for DA

A 04.04.24 Issue for Review B 18.04.24 Issue for Review C 23.04.24 Issue for DA

Project no. JEK2402

Drawing Noise

advisory

27.03.24

Project **Futuro**

Leppington

Park

BA/JM Signtype

Drawn/Checked

Drawing number JEK2163B-O1-002






03 Type detail Typical 70mm cap height Scale 1:1

km/hr

04 Type detail Typical 25mm cap height Scale 1:1

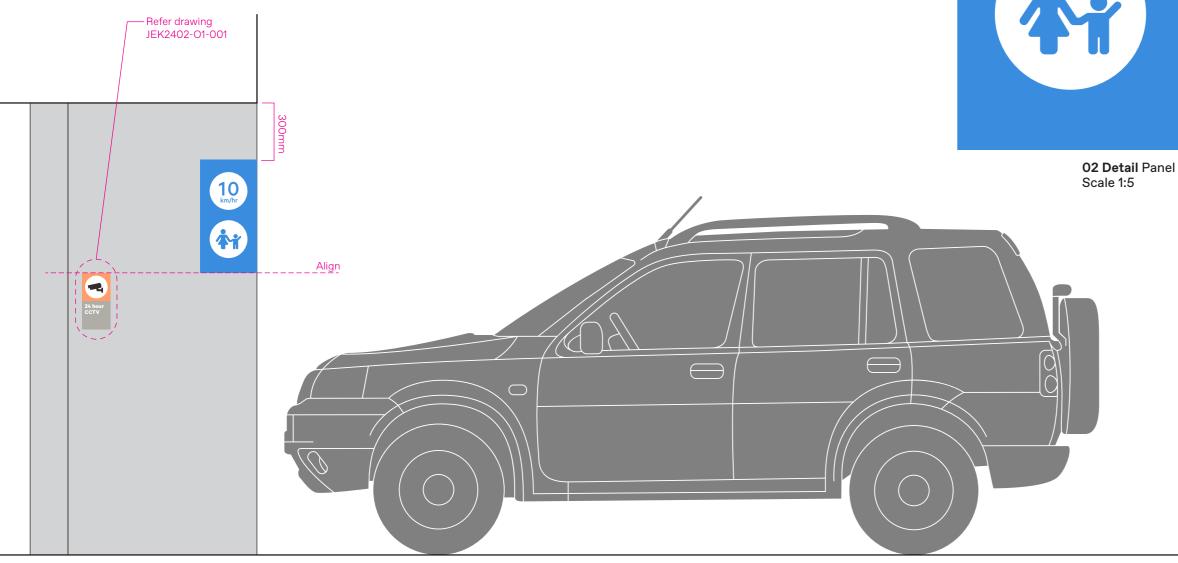

01 Part section Driveway Scale 1:20

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Issue Issue for DA Revisions

A 04.04.24 Issue for Review B 18.04.24 Issue for Review C 23.04.24 Issue for DA Project no. JEK2402

Drawing
Operational
T&Cs

Date 27.03.24

300mm

Project Futuro

Park

Leppington

BA/JM
Signtype
O.3.2

Drawn/Checked BA/JM

Drawing number **JEK2402-032-001**

Revision

notes.

CONTENT As documented

NOTES GENERAL

MATERIALITY

FABRICATION

exposed surfaces.

finish.

FIXING

The signs/graphics are located to provide operational information to arriving/departing visitors, including speed recommendations. The signs/graphics are located in an external/internal public environment, as such all materials, fabrication and fixing to suit expected conditions.

2mm painted Aluminium sign panel with external grade cast vinyl solid colour film graphics applied to sign panel with clear overcoat. To be satin

illustrations adjacent. All edges to be

smoothed slightly rounded to ensure

no sharp edges. To be painted on all

As illustrated. For colour specification

Permanent conceal adhesive fix panel to base building wall surface via Soudal Fixall adhesive silicone or similar equivalent. Utilise suitable adhesive for fixing surfaces/finishes,

prepared and installed to manufacturers specifications.

FINISHES/COLOUR

GRAPHICS

achieve a clean cut.

LOCATING PRINCIPLES

refer Graphic standards

To be two pack polyurethane, external grade paint system.

Anti-graffiti satin finish 25% gloss level to all exposed surfaces.


Graphics to be external grade cast vinyl solid colour film, Premium Cast Avery or similar equivalent, vinyl installed to manufacturers specifications. All lettering/forms shall be sharp and true to the selected typeface and artwork. Pre-spaced and electronically cut vinyl film, ensure cut edges are not overheated and are cut slowly to

As noted on elevation and setout

Final setout to be reviewed and agreed on site with client.

Fabricated sign panel as per



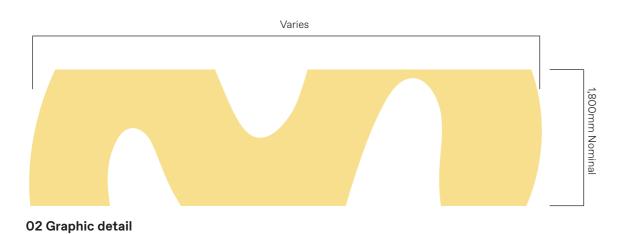



03 Montage NTS

NOTES

GENERAL

The graphics are applied directly to the timber fency to the boundary, creating a colourful and engaging feature to the vehicular & pedestrian journey around the site. The graphics are located in a public environment, as such all materials, fabrication and fixing to suit expected conditions.

MATERIALITY

Graphic pattern to be by hand signwriting direct to wall surface, using external grade paint system.

FABRICATION

Prepare wall, preparing and finishing to ensure permanent adhesion of graphics.


FINISHES/COLOUR To be DULUX 2-pak paint external grade paint system

Text and graphics to be as per artwork

For colour specification refer Graphic standards

Anti-graffiti satin finish 25% gloss level to all exposed surfaces

GRAPHICS Signwriting by hand

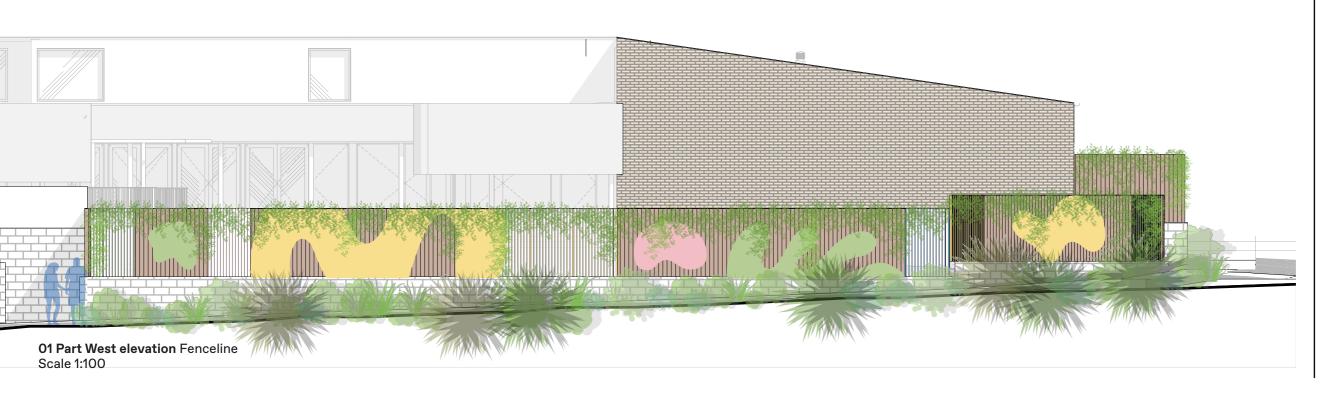



Typical section Scale 1:50



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Issue Issue for DA

Revisions

A 04.04.24 Issue for Review B 18.04.24 Issue for Review C 23.04.24 Issue for DA

Project no. JEK2402

Drawing External Supergraphics Date 27.03.24

Leppington

Futuro

Park

Project


BA/JM Signtype


P.1.1

Drawn/Checked

JEK2402-P11-001



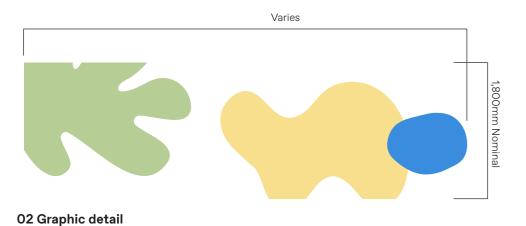

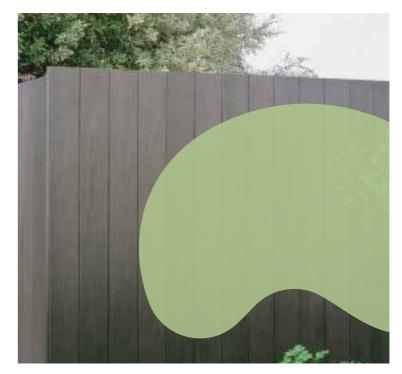

03 MontageTypical graphic to timber fence NTS

NOTES

GENERAL

The graphics are applied directly to the timber fency to the boundary, creating a colourful and engaging feature to the vehicular & pedestrian journey around the site. The graphics are located in a public environment, as such all materials, fabrication and fixing to suit expected conditions.

MATERIALITY

Graphic pattern to be by hand signwriting direct to wall surface, using external grade paint system.

FABRICATION

Prepare wall, preparing and finishing to ensure permanent adhesion of graphics.


FINISHES/COLOUR
To be DULUX 2-pak paint external grade paint system

Text and graphics to be as per artwork

For colour specification refer Graphic standards

Anti-graffiti satin finish 25% gloss level to all exposed surfaces

GRAPHICS Signwriting by hand

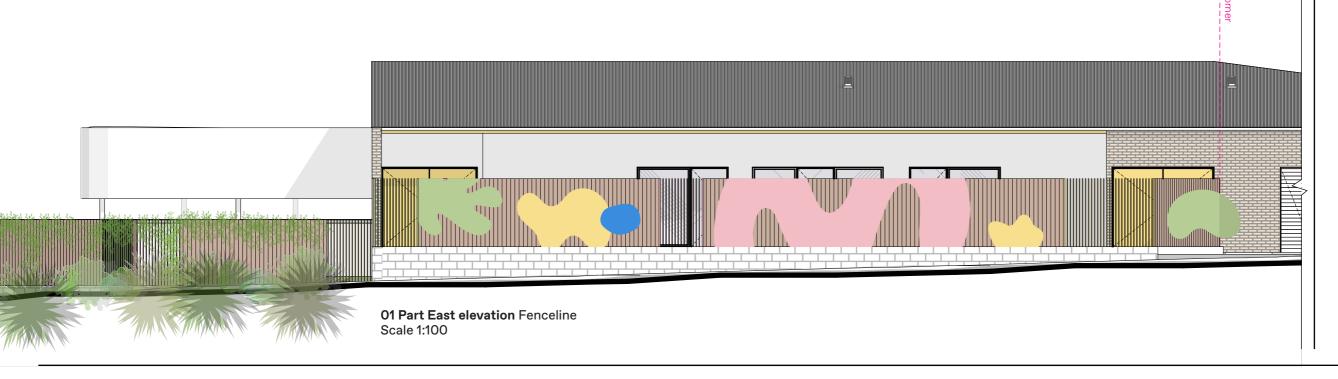

M ⊳ ∢ T

Typical section

Scale 1:50

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Issue Issue for DA Revisions A 04.0

A 04.04.24 Issue for Review B 18.04.24 Issue for Review C 23.04.24 Issue for DA

Project no. JEK2402

Drawing
External
Supergraphics

27.03.24 Project

Leppington

Futuro

Park

Date

BA/JM Signtype

P.1.1


Drawn/Checked BA/JM

Drawing number **JEK2402-P11-002**





-2 Montage NTS

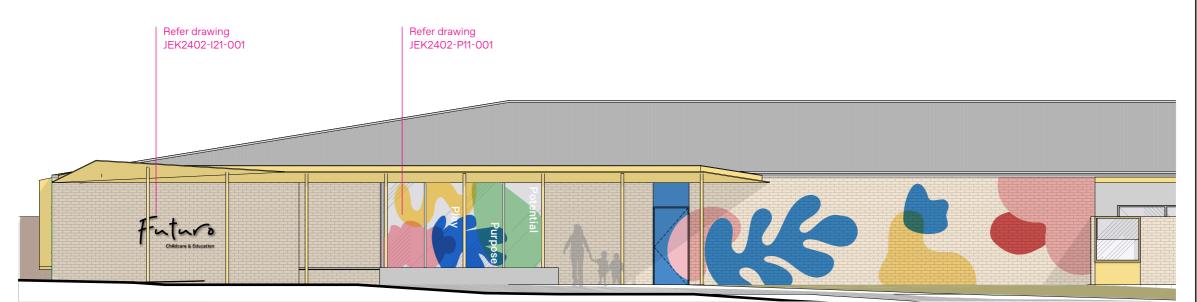

01 Part South elevation Park Rd Scale 1:50



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Issue Issue for DA Revisions
A 04.04.24 Issue for Review
B 18.04.24 Issue for Poview

B 18.04.24 Issue for Review C 23.04.24 Issue for DA

Project no. JEK2402

Drawing
External
Supergraphics

Date 27.03.24

Leppington

Project

Park

Futuro

BA/JM
Signtype

P.1.1

Drawn/Checked Drawing r
BA/JM JEK2

JEK2402-P11-003

Revision **C**

NOTES GENERAL

The graphics are applied directly to the masonry wall adjacent the pedestrian entry, creating a colourful and engaging feature to the primary facade. The graphics are located in a public environment, as such all materials, fabrication and fixing to

suit expected conditions.

Graphic pattern to be by hand signwriting direct to wall surface, using external grade paint system.

Prepare wall, preparing and finishing to ensure permanent adhesion of

To be DULUX 2-pak paint external

For colour specification refer Graphic

Anti-graffiti satin finish 25% gloss level to all exposed surfaces

Text and graphics to be as per

MATERIALITY

FABRICATION

FINISHES/COLOUR

grade paint system

graphics.


artwork

standards

GRAPHICS

Signwriting by hand



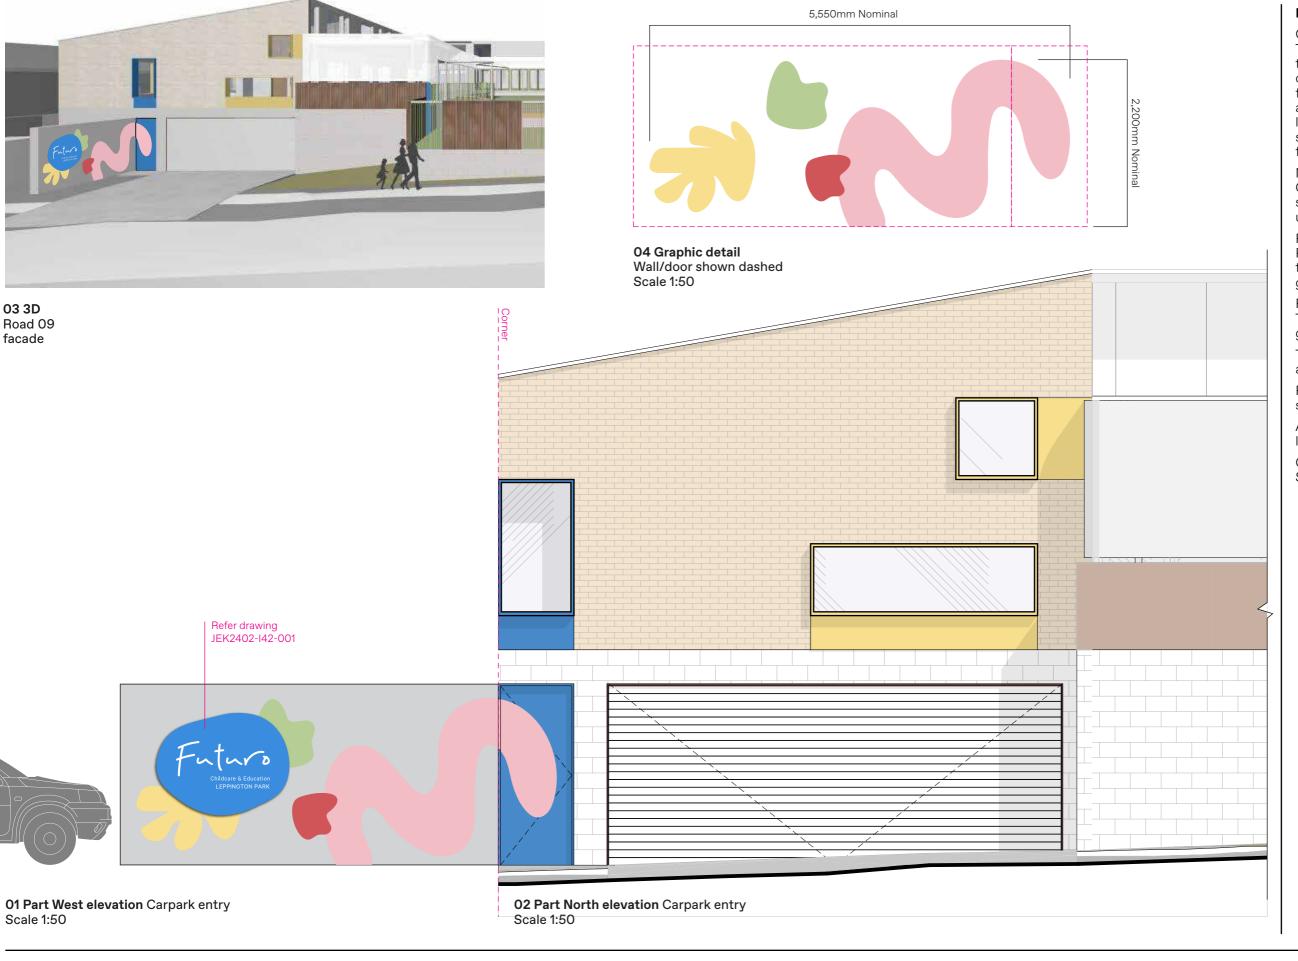



GENERAL

The graphics are applied directly to the wall adjacent the vehicular entry, creating a colourful and engaging feature to the primary vehicular arrival point. The graphics are located in a public environment, as such all materials, fabrication and fixing to suit expected conditions.

MATERIALITY

Graphic pattern to be by hand signwriting direct to wall surface, using external grade paint system.

FABRICATION

Prepare wall, preparing and finishing to ensure permanent adhesion of graphics.

FINISHES/COLOUR To be DULUX 2-pak paint external grade paint system

Text and graphics to be as per artwork

For colour specification refer Graphic standards

Anti-graffiti satin finish 25% gloss level to all exposed surfaces

GRAPHICS Signwriting by hand

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Issue Issue for DA

Revisions

A 04.04.24 Issue for Review B 18.04.24 Issue for Review C 23.04.24 Issue for DA

Project no. JEK2402

Drawing External Supergraphics Date 27.03.24

Leppington

Futuro

Park

Project

Drawn/Checked BA/JM Signtype

P.1.1

JEK2402-P11-004





04 Reference Transparent vinyl Supplier: solyxfilms.com

Play

03 Type detail 280mm cap height Scale 1:10



Notes

GENERAL

The signs/graphics are located in internal public environment, as such all materials, fabrication and fixing to suit expected conditions.

MATERIALITY

Shapes

To be solyxfilms.com Transparent Polyester Colors Window Films or similar equivalent, transparent self adhesive vinyl installed to manufacturers specifications.

Colours to be close as possible match to Futuro Brand colours.

Final specification to be approved by client - refer drawing GEN-001, 03 Samples.

Text

To be external grade cast vinyl solid colour film, Premium Cast Avery vinyl installed to manufacturers specifications. To be satin finish.

Vinyl to be applied to each glazing section, inside face of fixed light. Text to be applied direct to glazing, coloured shapes to be applied over, ie second layer to glazing. Overlay coloured forms as illustrated.

FABRICATION

Electronically cut self adhesive vinyl film. Ensure all corners/edges are sharp and true to the artwork.

Ensure cut edges are not overheated and are cut slowly to achieve a clean cut.

GRAPHICS

Graphic form to appear continuous over the whole glazed section, ie line to be a continuous line over the vertical mullions.

LOCATING PRINCIPLES As noted on elevation and setout notes.

Scale 1:50



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Issue Issue for DA

Revisions

A 04.04.24 Issue for Review B 18.04.24 Issue for Review C 23.04.24 Issue for DA

Project no. JEK2402

Drawing

Glazing

supergraphic

-Play Purpose Potentiaark

Date 27.03.24

Project Futuro

Leppington

BA/JM Signtype

P.1.2

Drawn/Checked


Drawing number JEK2402-P12-001



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1	/\	,	ı	_

POWER

- -Power requirements are noted below; MPN-002
- -I.1
- -I.2.1
- -D.2

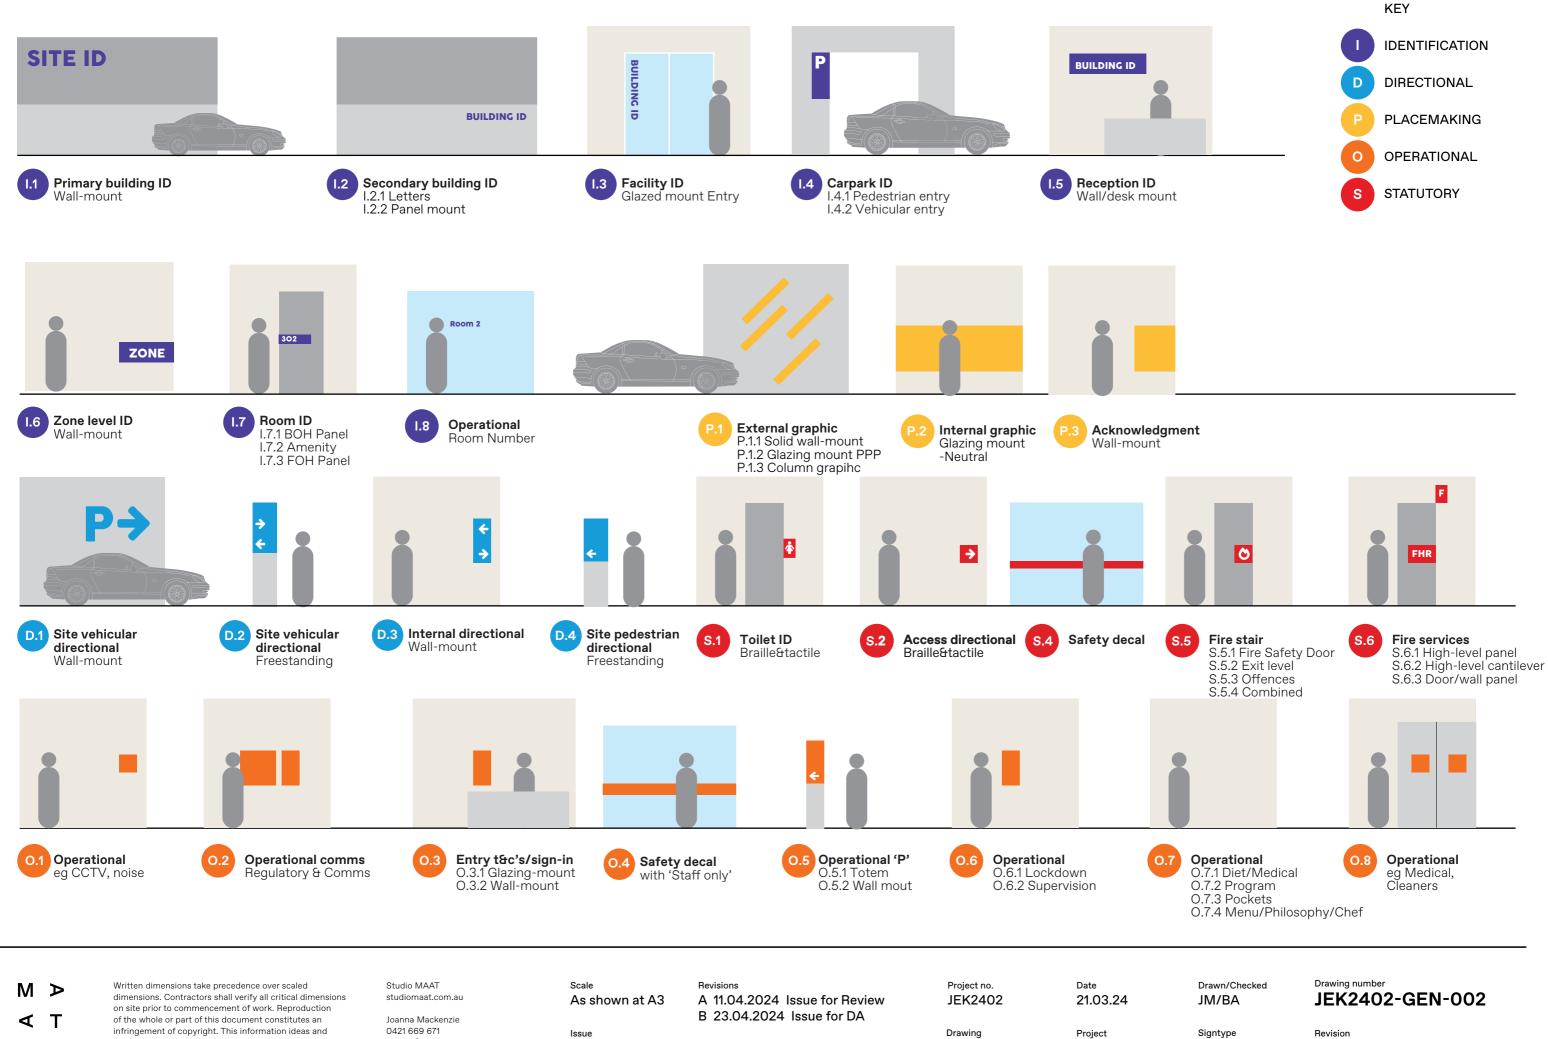

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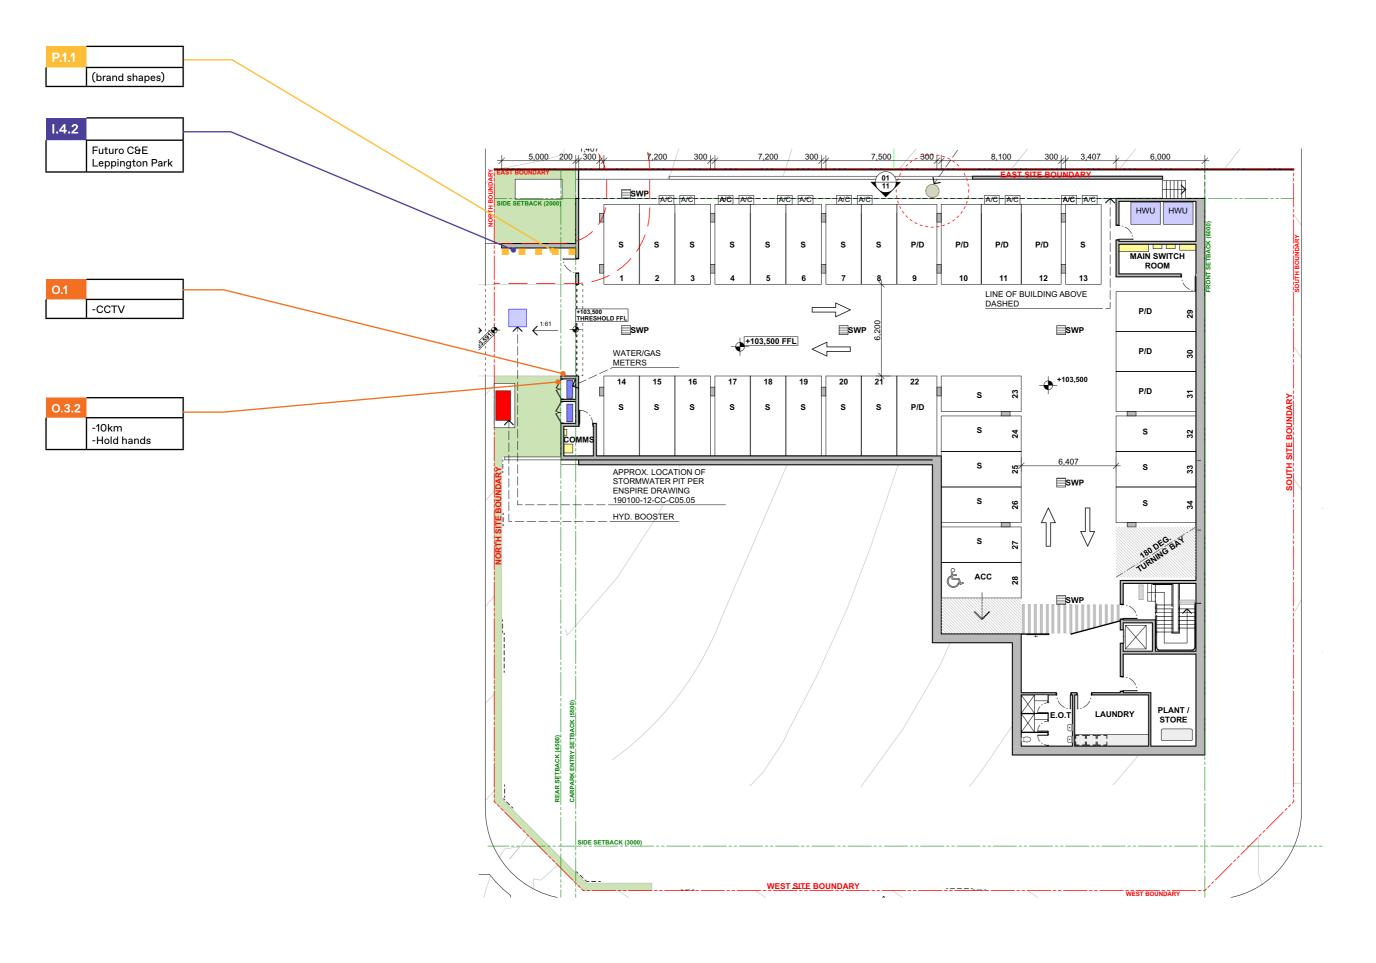
Issue for

DA

Sign Hierarchy

Futuro Leppington Park

В





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Scale As shown at A3

Issue Issue for DA

Revisions

A 11.04.2024 Issue for Review B 23.04.2024 Issue for DA

Project no. JEK2402 Drawing

Lower Ground

Site

21.03.24 Project

Futuro

Leppington Park

Date


JM/BA Signtype

Drawing number Drawn/Checked

JEK2402-MPN-001

Revision В



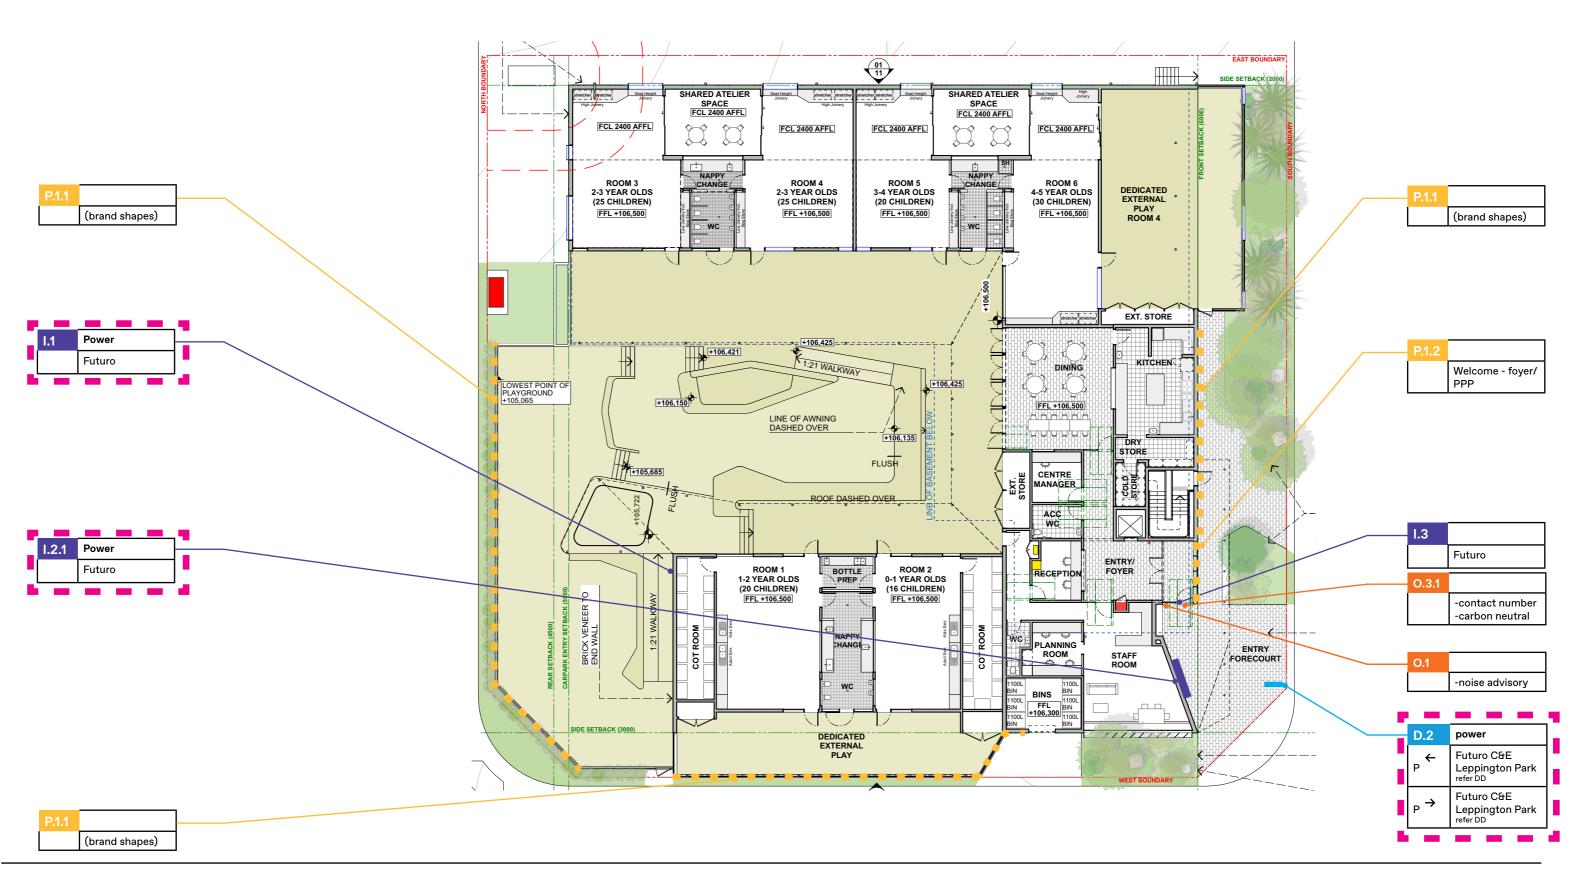



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Issue Issue for DA

Revisions

A 11.04.2024 Issue for Review B 23.04.2024 Issue for DA

Drawing **Ground Site**

Project no.

JEK2402

Date 21.03.24

Leppington Park

Futuro

Project Signtype

Drawn/Checked JM/BA

Drawing number JEK2402-MPN-002

Revision В



PROPOSED CHILDCARE CENTRE AT 52 PARK ROAD, LEPPINGTON

- These drawings shall be read in conjunction with all architectural and other consultants drawings and specifications and with such other written instructions and sketches as may be issued during the course of the Contract. Any discrepancies shall be referred to the Superintendent before proceeding with any related works. Construction from these drawings, and their associated consultant's drawings is not to commence until approved by the Local Authorities.
- All materials and workmanship shall be in accordance with the relevant and current Standards Australia codes and with the By-Laws and Ordinances of the relevant building authorities except where varied by the project specification.
- All set out dimensions shall be obtained from Architect's and Engineer's details. All discrepancies shall be referred to the Architect and Engineer for decision before proceeding with related work.
- During construction the structure shall be maintained in a stable condition and no part shall be overstressed. Temporary bracing shall be provided by the builder/subcontractor to keep the works and excavations stable
- G5 Unless noted otherwise levels are in metres and dimensions are in millimetres.
- The alignment and level of all services shown are approximate only. The contractor shall confirm the position and level of all services prior to commencement of construction. Any damage to services shall be rectified at the contractors expense.

G7 Any substitution of materials shall be approved by the Engineer and included in any tender.


- **G8** All services, or conduits for servicing shall be installed prior to commencement of pavement construction.
- Subsoil drainage, comprising 100 agriculture pipe in geo-stocking to be placed as shown and as may be directed by the superintendent. Subsoil drainage shall be constructed in accordance with the relevant local authority construction specification.
- G10 The structural components detailed on these drawings have been designed in accordance with the relevant Standards Australia codes and Local Government Ordinances for the following loadings. Refer to the Architectural drawings for proposed floor usage. Refer to drawings for live loads and superimposed dead


DRAINAGE NOTES

- **D1** All drainage levels to be confirmed on site, prior to any construction commencing.
- All pipes within the property to be a minimum of 100 dia upvc @ 1% minimum grade, uno.
- D3 All pits within the property are to be fitted with "weldlok" or approved equivalent grates: - Light duty for landscaped areas
- Heavy duty where subjected to vehicular traffic **D4** All pits within the property to be constructed as one of the following:
- 1) Precast stormwater pits
- 2) Cast insitu mass concrete 3) Cement rendered 230mm brickwork subject to the relevant local authority construction specification.
- D5 Ensure all grates to pits are set below finished surface level within the property. Top of pit RL's are approximate only and may be varied subject to approval of the engineer. All invert levels are to be achieved.
- D6 Any pipes beneath relevant local authority road to be rubber ring jointed RCP, uno.
- **D7** All pits in roadways are to be fitted with heavy duty grates with locking bolts and continuous hinge.
- **D8** Provide step irons to stormwater pits greater than 1200 in depth.
- Trench back fill in roadways shall comprise sharp, clean granular back fill in accordance with the relevant local authority specification to non-trafficable areas to be compacted by rodding and tamping using a flat
- **D10** Where a high early discharge (hed) pit is provided all pipes are to be connected to the hed pit, uno.
- D11 Down pipes shall be a minimum of dn100 sw grade upvc or 100 x100 colorbond/zincalume steel, uno.
- D12 Colorbond or zincalume steel box gutters shall be a minimum of 450 wide x 150 deep.
- D13 Eaves gutters shall be a minimum of 125 wide x 100 deep (or of equivalent area) colorbond or zincalume
- D14 Subsoil drainage shall be provided to all retaining walls & embankments, with the lines feeding into the

EROSION AND SEDIMENT CONTROL NOTES

- These notes are to be read in conjunction with erosion and sediment control details in this drawing set.
- E2 The contractor shall implement all soil erosion and sediment control measures as necessary and to the satisfaction of the relevant local authority prior to the commencement of and during construction. No disturbance to the site shall be permitted other than in the immediate area of the works and no material shall be removed from the site without the relevant local authority approval. All erosion and sediment control devices to be installed and maintained in accordance with standards outlined in nsw department of housing's "managing urban stormwater - soils and constructions".
- Place straw bales length wise in a row as parallel as possible to the site contours, uno. Bale ends to be tightly butted. Bales are to be placed so that straws are parallel to the row. Bales are to be placed 1.5m to 2m downslope from the toe of the disturbed batter, uno.
- **E4** Council approved filter fabric to be entrenched 150mm deep upslope towards disturbed surface. Fabric to be a minimum SF2000 or better. Fix fabric to posts with wire ties or as recomended with manufacturer's specifications. Fabric joints to have a minimum of 150mm overlap. Wire to be strung between posts with filter fabric overlap to prevent sagging.
- Stabalised entry/exit points to remain intact until finished driveway is complete. Construction of entry/exit points to be maintained and repaired as required so that it's function is not compromised. Construction of entry/exit point to be in accordance with the detail contained within this drawing set.
- All drainage pipe inlets to be capped until:
- downpipes connected - pits constructed and protected with silt barrier
- Provide and maintain silt traps around all surface inlet pits until catchment is revegetated or paved.
- The contractor shall regularly maintain all erosion and sediment control devices and remove accumulated silt from such devices such that more than 60% of their capacity is lost. All the silt is to be placed outside the limit of works. The period for maintaining these devices shall be at least until all disturbed areas are revegetated and further as may be directed by the superintendent or council.
- The contractor shall implement dust control by regularly wetting down (but not saturating) disturbed area.
- Topsoil shall be stripped and stockpiled outside hazard areas such as drainage lines. This topsoil shall be respread later on areas to be revegetated and stabilised only, (i.e. all footpaths, batters, site regarding areas, basins and catchdrains). Topsoil shall not be respread on any other areas unless specifically instructed by the superintendent. If they are to remain for longer than one month stockpiles shall be protected from erosion by covering them with a mulch and hydroseeding and, if necessary, by locating banks or drains downstream of a stockpile to retard silt laden runoff.
- **E10** Lay 300 wide minimum turf strip on 100 topsoil behind all kerb and gutter with 1000 long returns every 6000 and around structures immediately after backfilling as per the relevant local authority specification.
- **E11** The contractor shall grass seed all disturbed areas with an approved mix as soon as practicable after completion of earthworks and regrading.
- **E12** Revegetate all trenches immediately upon completion of backfilling.
- **E13** When any devices are to be handed over to council they shall be in clean and stable condition.

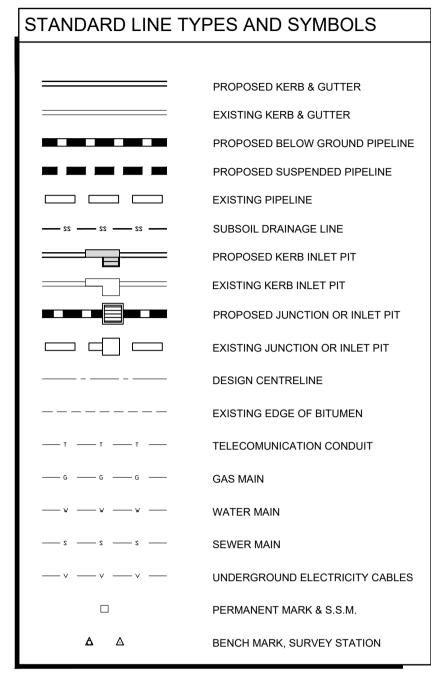

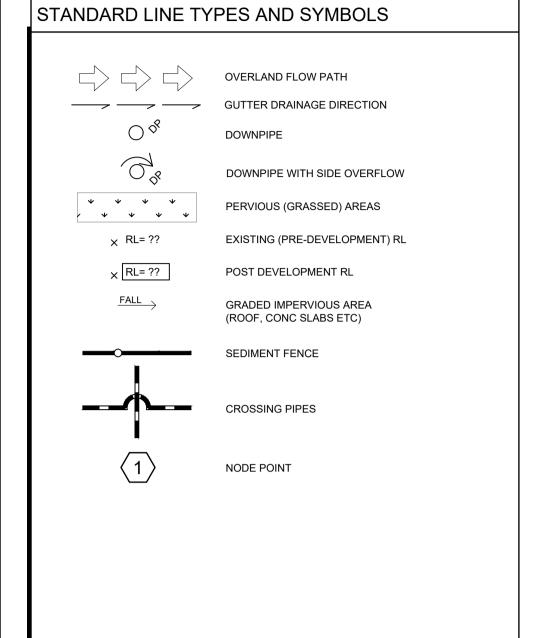

LEGE			
AHD	Australian height datum	SS	Stainless steel
AG	Ag-pipe (Sub soil drainage)	SU	Box gutter sump
ARI	Average recurrence interval Box Gutter	TW	Top of wall
BG BWL	Box Gutter Bottom water level	TWL U/S	Top water level Underside of slab
CL	Cover level	VG	
CO	•	UNO	Vally gutter Unless noted otherwise
DCP	Clean out inspection opening Discharge control pit	UNO	Offiess floted otherwise
DCF	Down pipe		
DRP	Dropper pipe		
EBG	Existing box gutter		
EDP	Existing down pipe		
EEG	Existing eaves gutter		
EG	Eaves gutter		
FRC	Fiber reinforced concrete		
FW	Floor waste		
GD	Grated drain		
GSIP	Grated surface inlet pit		
HED	High early discharge		
HP	High point of gutter		
IL	Invert level		
Ю	Inspection opening		
O/F	Overflow		
OSD	On-site detention		
PSD	Permissible site discharge		
P1	Pipe 1		
RCP	Reinforced concrete pipe		
RHS	Rectangular hollow section		
RL	Reduced level		
RRJ	Rubber ring joint		
RRT RWH	Rainwater re-use tank Rain water head		
RWH			
SLAP	Rain water outlet Sealed lid access pit		
SP	Spreader pipe		
SPR	Spreader pipe Spreader		

RECOMMENDED MAINTENA	NCE SCHED	ULE	
DISCHARGE CONTROL PIT (DCP)	FREQUENCY	RESPONSIBILITY	PROCEDURE
Inspect flap valve and remove any blockage.	Six monthly	Owner	Remove grate. Ensure flap valve moves freely and remove any blockages or debris.
Inspect screen and clean.	Six monthly	Owner	Revove grate and screen if required and clean it.
Inspect & remove any blockage of orifice.	Six monthly	Owner	Remove grate & screen to inspect orifice. see plan for location of dcp.
Inspect dcp sump & remove any sediment-sludge.	Six monthly	Owner	Remove grate and screen. Remove sediment/sludge build-up and check orifice and flap valve clear.
Inspect grate for damage or blockage.	Six monthly	Owner	Check both sides of grate for corrosion, (especially corners and welds) damage or blockage.
Inspect return pipe from storage and return any blockage.	Six monthly	Owner	Remove grate and screen. ventilate underground storage if present. open flap valve and remove any blockages in return line. Check for sludge/debris on upstream side of return line.
Inspect outlet pipe and remove any blockage.	Six monthly	Maintenance Contractor	Remove grate and screen. ventilate underground storage if present. Check orifice and remove any blockages in outlet pipe. Flush outlet pipe to confirm it drains freely. Check for sludge/debris on upstream side of return line.
Check fixing of step irons is secure.	Six monthly	Maintenance Contractor	Remove grate and ensure fixings secure prior to placing weight on step iron.
Inspect overflow weir & remove any blockage.	Six monthly	Maintenance Contractor	Remove grate and open cover to ventilate underground storage if present. ensure weir clear of blockages.
Empty basket at overflow weir (if present).	Six monthly	Maintenance Contractor	Remove grate and ventilate underground storage chamber if present. Empty basket, check fixings secure and not corroded.
Check attachment of orifice plate to wall of pit (gaps less than 5 mm).	Annually	Maintenance Contractor	Remove grate and screen. ensure plate mounted securely, tighten fixings if required. seal gaps as required.
Check attachment of screen to wall of pit.	Annually	Maintenance Contractor	Remove grate and screen. ensure screen fixings secure. repair as required.
Check screen for corrosion.	Annually	Maintenance Contractor	Remove grate and examine screen for rust or corrosion, especially at corners or welds.
Check attachment of flap valve to wall of .	Annually	Maintenance Contractor	Remove grate. Ensure fixings of valve are secure.
Check flap valve seals against wall of pit.	Annually	Maintenance Contractor	Remove grate. fill pit with water and check that flap seals against side of pit with minimal leakage.
Check any hinges of flap valve move freely.	Annually	Maintenance Contractor	Remove grate. Test valve hinge by moving flap to full extent.
Inspect dcp walls (internal and external, if appropriate) for cracks or spalling.	Annually	Maintenance Contractor	Remove grate to inspect internal walls. Repair as required. Clear vegetation from external walls if necessary and repair as required.
Check step irons for corrosion.	Annually	Maintenance Contractor	Remove grate. Examine step irons and repair any corrosion or damage.
Check orifice diameter correct and retains sharp edge.	Five yearly	Maintenance Contractor	Compare diameter to design (see work-as- executed) and ensure edge is not pitted or damaged.
STORAGE			
Inspect & remove any blockage of orifice.	Six monthly	Owner	Remove grate and screen. remove sediment/sludge build-up.
Check orifice diameter correct and retains sharp edge.	Six monthly	Owner	Remove blockages from grate and check if pit blocked.
Inspect screen and clean.	Six monthly	Owner	Remove debris and floatable material likely to be carried to grates.
Check attachment of orifice plate to wall of pit (gaps less than 5 mm).	Annually	Maintenance	Remove grate to inspect internal walls. repair as required. clear vegetation from external wall if necessary and repair as required.
Check attachment of screen to wall of pit.	Five yearly	Maintenance Contractor	Compare actual storage available with work-as executed plans. If volume loss is greater than 5%, arrange for reconstruction to replace the volume lost. Council to be notified of the proposal.
Check attachment of screen to wall of pit.	Five yearly	Maintenance Contractor	Check along drainage lines and at pits for subsidence likely to indicate leakages.

NOTE: DO NOT SCALE OFF DRAWINGS. REFER TO ARCHITECTURAL PLANS. VERIFY DIMENSIONS ON SITE

Α	03.05.24	ISSUED FOR APPROVAL	F.I.
REV	DATE	DESCRIPTION	BY

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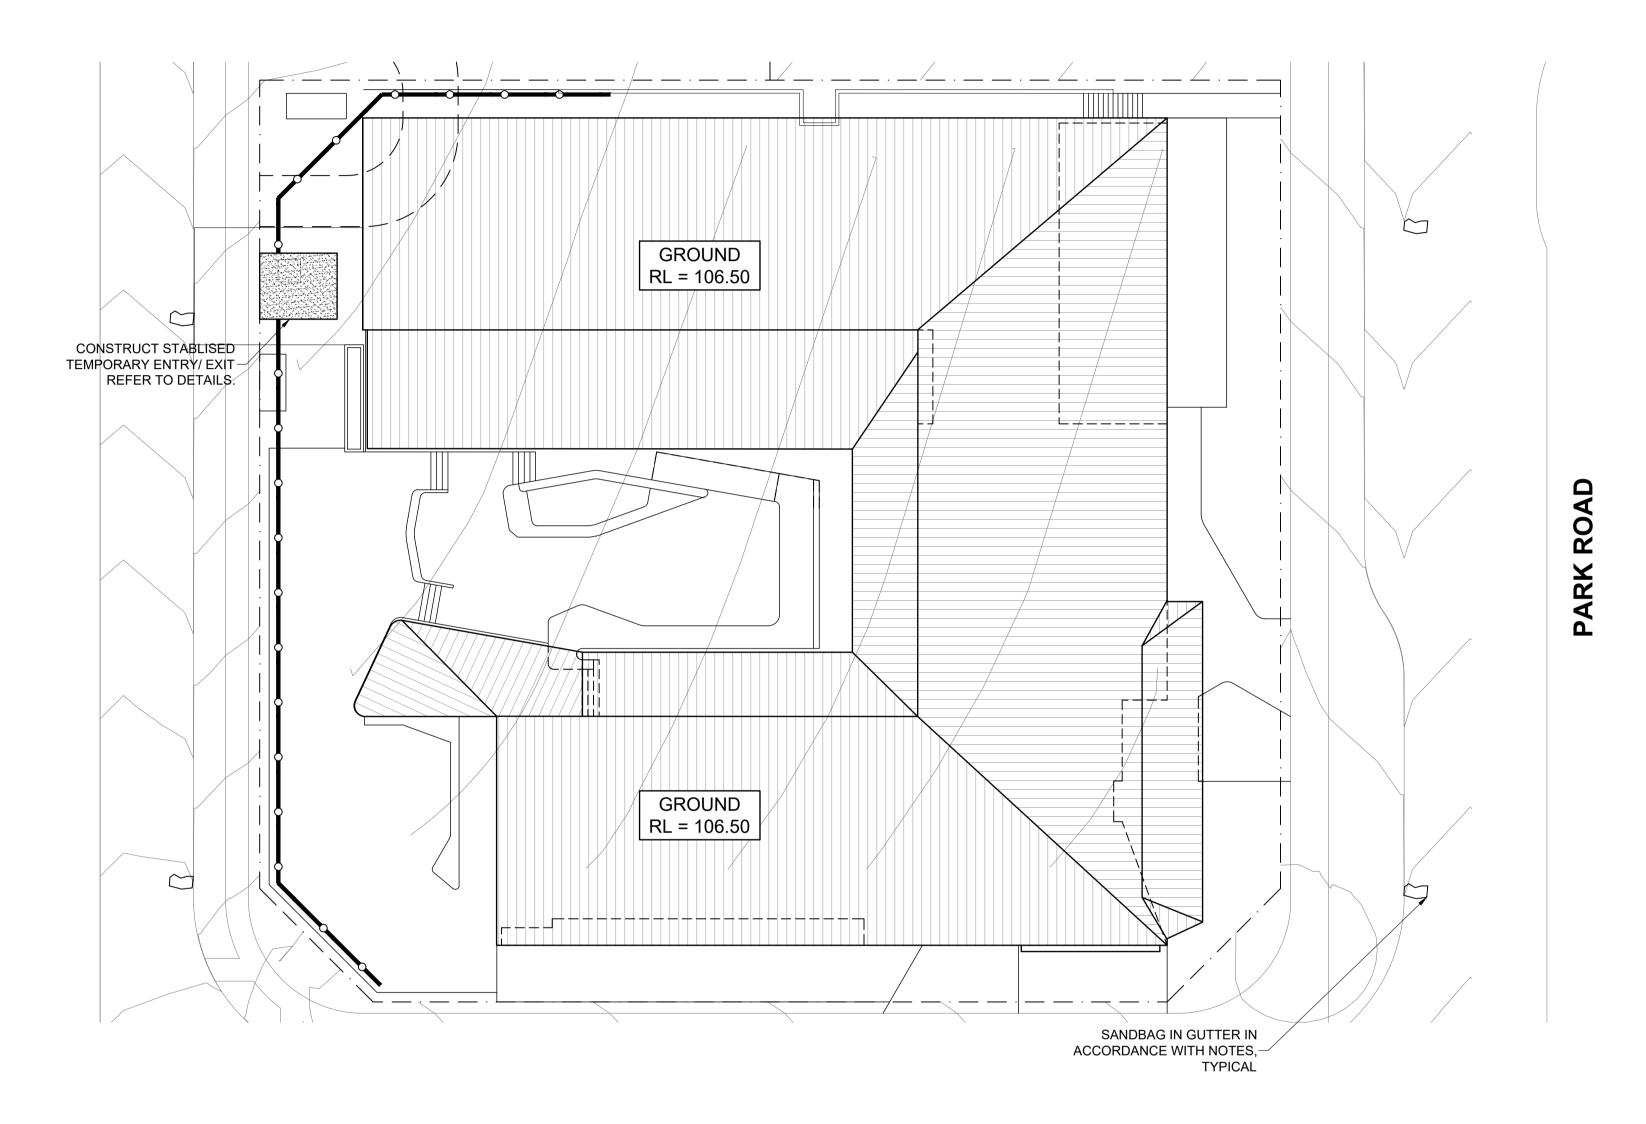
Phone: (02) 8020 2960 Email: info@engineeringstudio.com.au PO Box 7191

Web: www.engineeringstudio.com.au NORWEST NSW 2153

PROPOSED CHILDCARE CENTRE AT 52 PARK ROAD, LEPPINGTON **FOR JECKRA**

GENERAL NOTES

JOB NUMBER:	DWG NUMBER:	ORIGINAL SIZE:
230996	C00.01	A1
DESIGNED BY: F.I.	DATE: APRIL 2024	
DRAWN BY: M.W.	SCALE: SCALE	



SEDIMENT & EROSION CONTROL PLAN

- DENOTES SEDIMENT FENCE

COMMENCEMENT OF WORKS

THE CONTRACTOR SHALL ENSURE THAT NO SPOIL OR FILL ENCROACHES UPON ADJACENT AREAS FOR THE DURATION OF WORKS.

THE CONTRACTOR SHALL ENSURE THAT KERB INLETS AND DRAINS RECEIVING STORMWATER SHALL BE PROTECTED AT ALL TIMES DURING DEVELOPMENT. KERB INLET SEDIMENT TRAPS SHALL BE INSTALLED ALONG THE IMMEDIATE VICINITY ALONG THE STREET FRONTAGE.


SEDIMENT FENCING SHALL BE SECURED BY POST (WHERE METAL STAR PICKETS ARE USED PLASTIC SAFETY CAPS SHALL BE USED) AT 2000 INTERVALS WITH GEOTEXTILE FABRIC EMBEDDED 200 IN SOIL.

ALL TOPSOIL STRIPPED FORM THE SITE AND STOCKPILED DOES NOT INTERFERE WITH DRAINAGE LINES AND STORMWATER INLETS AND WILL BE SUITABLY COVERED WITH AN IMPERVIOUS MEMBRANE MATERIAL AND SCREENED BY SEDIMENT FENCING.

SEDIMENT TRAP

1000 x 1000 WIDE 500 DEEP PIT, LOCATED AT THE LOWEST POINT TO THE TRAP


WASHOUT AREA TO BE 1800 x 1800 ALLOCATED FOR THE WASHING OF TOOL & EQUIPMENT.

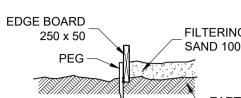


SEDIMENT FENCE

PROVIDE 'SEDIMENT FENCE ON DOWN SLOPE BOUNDARY AS SHOWN

FABRIC TO BE BURIED BELOW GROUND AT LOWER EDGE.

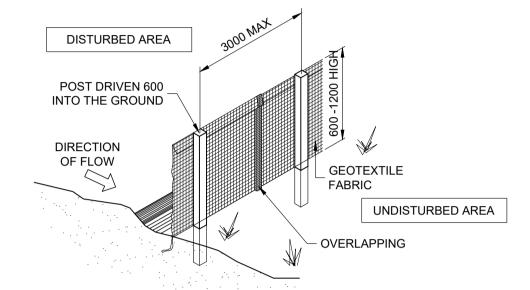


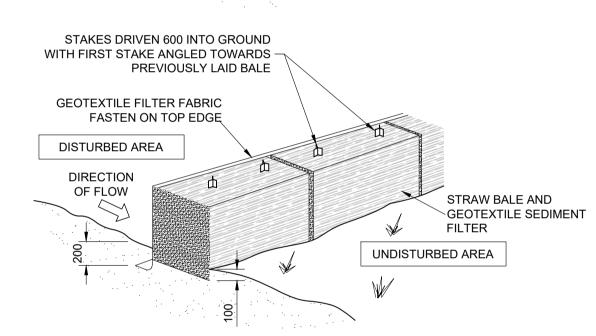

DRAINAGE AREA 0.5 HA. MAX. SLOPE GRADIENT 1:2 MAX. SLOPE LENGTH 50m.

TEMPORARY CONSTRUCTION ENTRY/EXIT


VEHICLE ACCESS TO THE BUILDING SITE SHOULD BE RESTRICTED TO A SINGLE POINT SO AS TO REDUCE THE AMOUNT OF SOIL DEPOSITED ON THE STREET PAVEMENT.

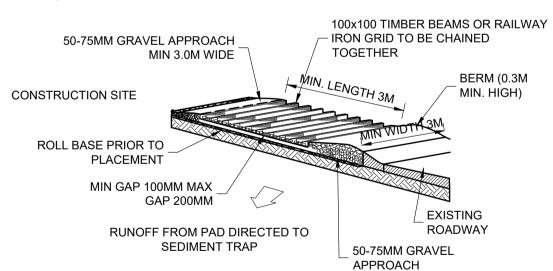

BUILDING MATERIAL STOCKPILE


ALL STOCKPILES OF BUILDING MATERIAL SUCH AS SAND AND SOIL MUST BE PROTECTED TO PREVENT SCOUR AND EROSION.

THEY SHOULD NEVER BE PLACED IN THE STREET GUTTER WHERE THEY WILL WASH AWAY WITH THE FIRST RAINSTORM.

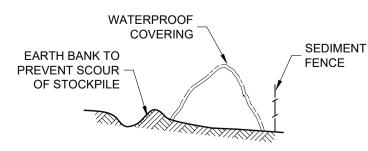

SANDBAG KERB SEDIMENT TRAP

IN CERTAIN CIRCUMSTANCES EXTRA SEDIMENT TRAPPING MAY BE NEEDED IN THE STREET GUTTER.

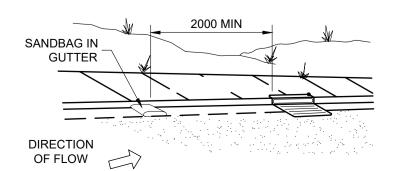

GENERAL NOTES

THESE DRAWINGS SHALL BE READ IN CONJUNCTION WITH OTHER CONSULTANTS' DRAWINGS AND SPECIFICATIONS AND WITH OTHER SUCH WRITTEN INSTRUCTIONS AS MAY BE ISSUED DURING THE COURSE OF THE CONTRACT. ANY DISCREPANCY SHALL BE REFERRED TO THE ENGINEER BEFORE PROCEEDING WITH THE WORK.

ALL DIMENSIONS ARE IN MILLIMETRES & ALL LEVELS ARE IN METRES, UNO (UNLESS NOTED OTHERWISE). NO DIMENSION SHALL BE OBTAINED BY SCALING

ALL LEVELS AND SETTING OUT DIMENSIONS SHOWN ON THE DRAWINGS SHALL BE CHECKED ON SITE PRIOR TO THE COMMENCEMENT OF THE WORK.

DURING EXCAVATION WORK THE STRUCTURE SHALL BE MAINTAINED IN A

STABLE AND NO PART SHALL BE OVERSTRESSED. ALL WORK IS TO BE UNDERTAKEN IN ACCORDANCE WITH THE DETAILS SHOWN

EXISTING SERVICES WHERE SHOWN HAVE BEEN PLOTTED FROM SUPPLIED DATA AND SUCH THEIR ACCURACY CAN NOT BE GUARANTEED. IT IS THE RESPONSIBILITY OF THE CONTRACTOR TO ESTABLISH THE LEVEL OF ALL EXISTING SERVICES PRIOR TO THE COMMENCEMENT OF WORK.

ALL SERVICE TRENCHES UNDER VEHICULAR PAVEMENTS SHALL BE BACK FILLED IN ACCORDANCE WITH THE REQUIREMENTS OF THE LOCAL COUNCIL.

ALL TRENCH BACK FILL MATERIAL SHALL BE COMPACTED TO THE SAME DENSITY AS THE ADJACENT MATERIAL.

ON COMPLETION OF STORMWATER INSTALLATION, ALL DISTURBED AREAS MUST BE RESTORED TO ORIGINAL CONDITION, INCLUDING KERBS, FOOTPATHS, CONCRETE AREAS, GRAVEL AND GRASSED AREAS AND ROAD PAVEMENTS, UNLESS DIRECTED OTHERWISE

CONTRACTOR TO OBTAIN ALL AUTHORITY APPROVALS UNLESS DIRECTED

STORMWATER DRAINAGE

ON THE DRAWINGS & THE SPECIFICATION.

THE STORMWATER DRAINAGE DESIGN HAS BEEN CARRIED OUT IN ACCORDANCE

AS/NZS 3500.3 - 1990 "STORMWATER DRAINAGE" & AS/NZS 3500.3.2-1998 "STORMWATER DRAINAGE - ACCEPTABLE SOLUTIONS".

ANY VARIATIONS TO THE NOMINATED LEVELS SHALL BE REFERRED TO ENGINEER IMMEDIATELY.

ANY VARIATIONS TO SPECIFIED PRODUCTS OR DETAILS SHALL BE REFERRED TO THE ENGINEER FOR APPROVAL.

DOWN PIPES SHALL BE A MINIMUM OF DN100 SW GRADE uPVC OR 100 X 100 COLORBOND OR ZINCALUME STEEL, UNO.

BOX COLORBOND OR ZINCALUME STEEL. GUTTERS SHALL BE A MINIMUM OF 450 WIDE X 150 DEEP.

EAVES GUTTERS SHALL BE A MINIMUM OF 125 WIDE X 100 DEEP (OR OF EQUIVALENT AREA) COLORBOND OR ZINCALUME STEEL.

SUBSOIL DRAINAGE SHALL BE PROVIDED TO ALL RETAINING WALLS & EMBANKMENTS, WITH THE LINES FEEDING INTO THE STORMWATER DRAINAGE SYSTEM.

SEDIMENT AND EROSION CONTROL NOTES

SEDIMENT AND EROSION CONTROL SHALL BE EFFECTIVELY MAINTAINED AT ALL TIMES DURING THE COURSE OF CONSTRUCTION AND SHALL NOT BE REMOVED UNTIL THE SITE HAS BEEN STABILISED OR LANDSCAPED TO THE SUPERINTENDENT'S SATISFACTION


A SINGLE ALL WEATHER ACCESS WAY WILL BE PROVIDED AT THE FRONT OF THE PROPERTY CONSISTING OF 50-75 AGGREGATE OR SIMILAR MATERIAL AT A MINIMUM THICKNESS OF 150 LAID OVER NEEDLE-PUNCHED GEOTEXTILE FABRIC AND CONSTRUCTED PRIOR TO COMMENCEMENT OF WORKS.

SOIL CONSERVATION NOTE

PRIOR TO COMMENCEMENT OF CONSTRUCTION PROVIDE 'SEDIMENT FENCE,' 'SEDIMENT TRAP' AND WASHOUT AREA TO ENSURE THE CAPTURE OF WATER BORNE MATERIAL GENERATED FROM THE SITE.

MAINTAIN THE ABOVE DURING THE COURSE OF CONSTRUCTION, AND CLEAR THE 'SEDIMENT TRAP AFTER EACH STORM.

NOTE: DO NOT SCALE OFF DRAWINGS. REFER TO ARCHITECTURAL PLANS. VERIFY DIMENSIONS ON SITE

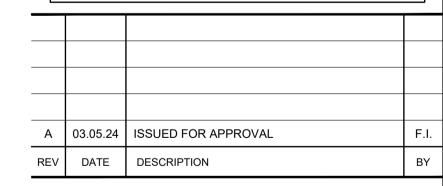

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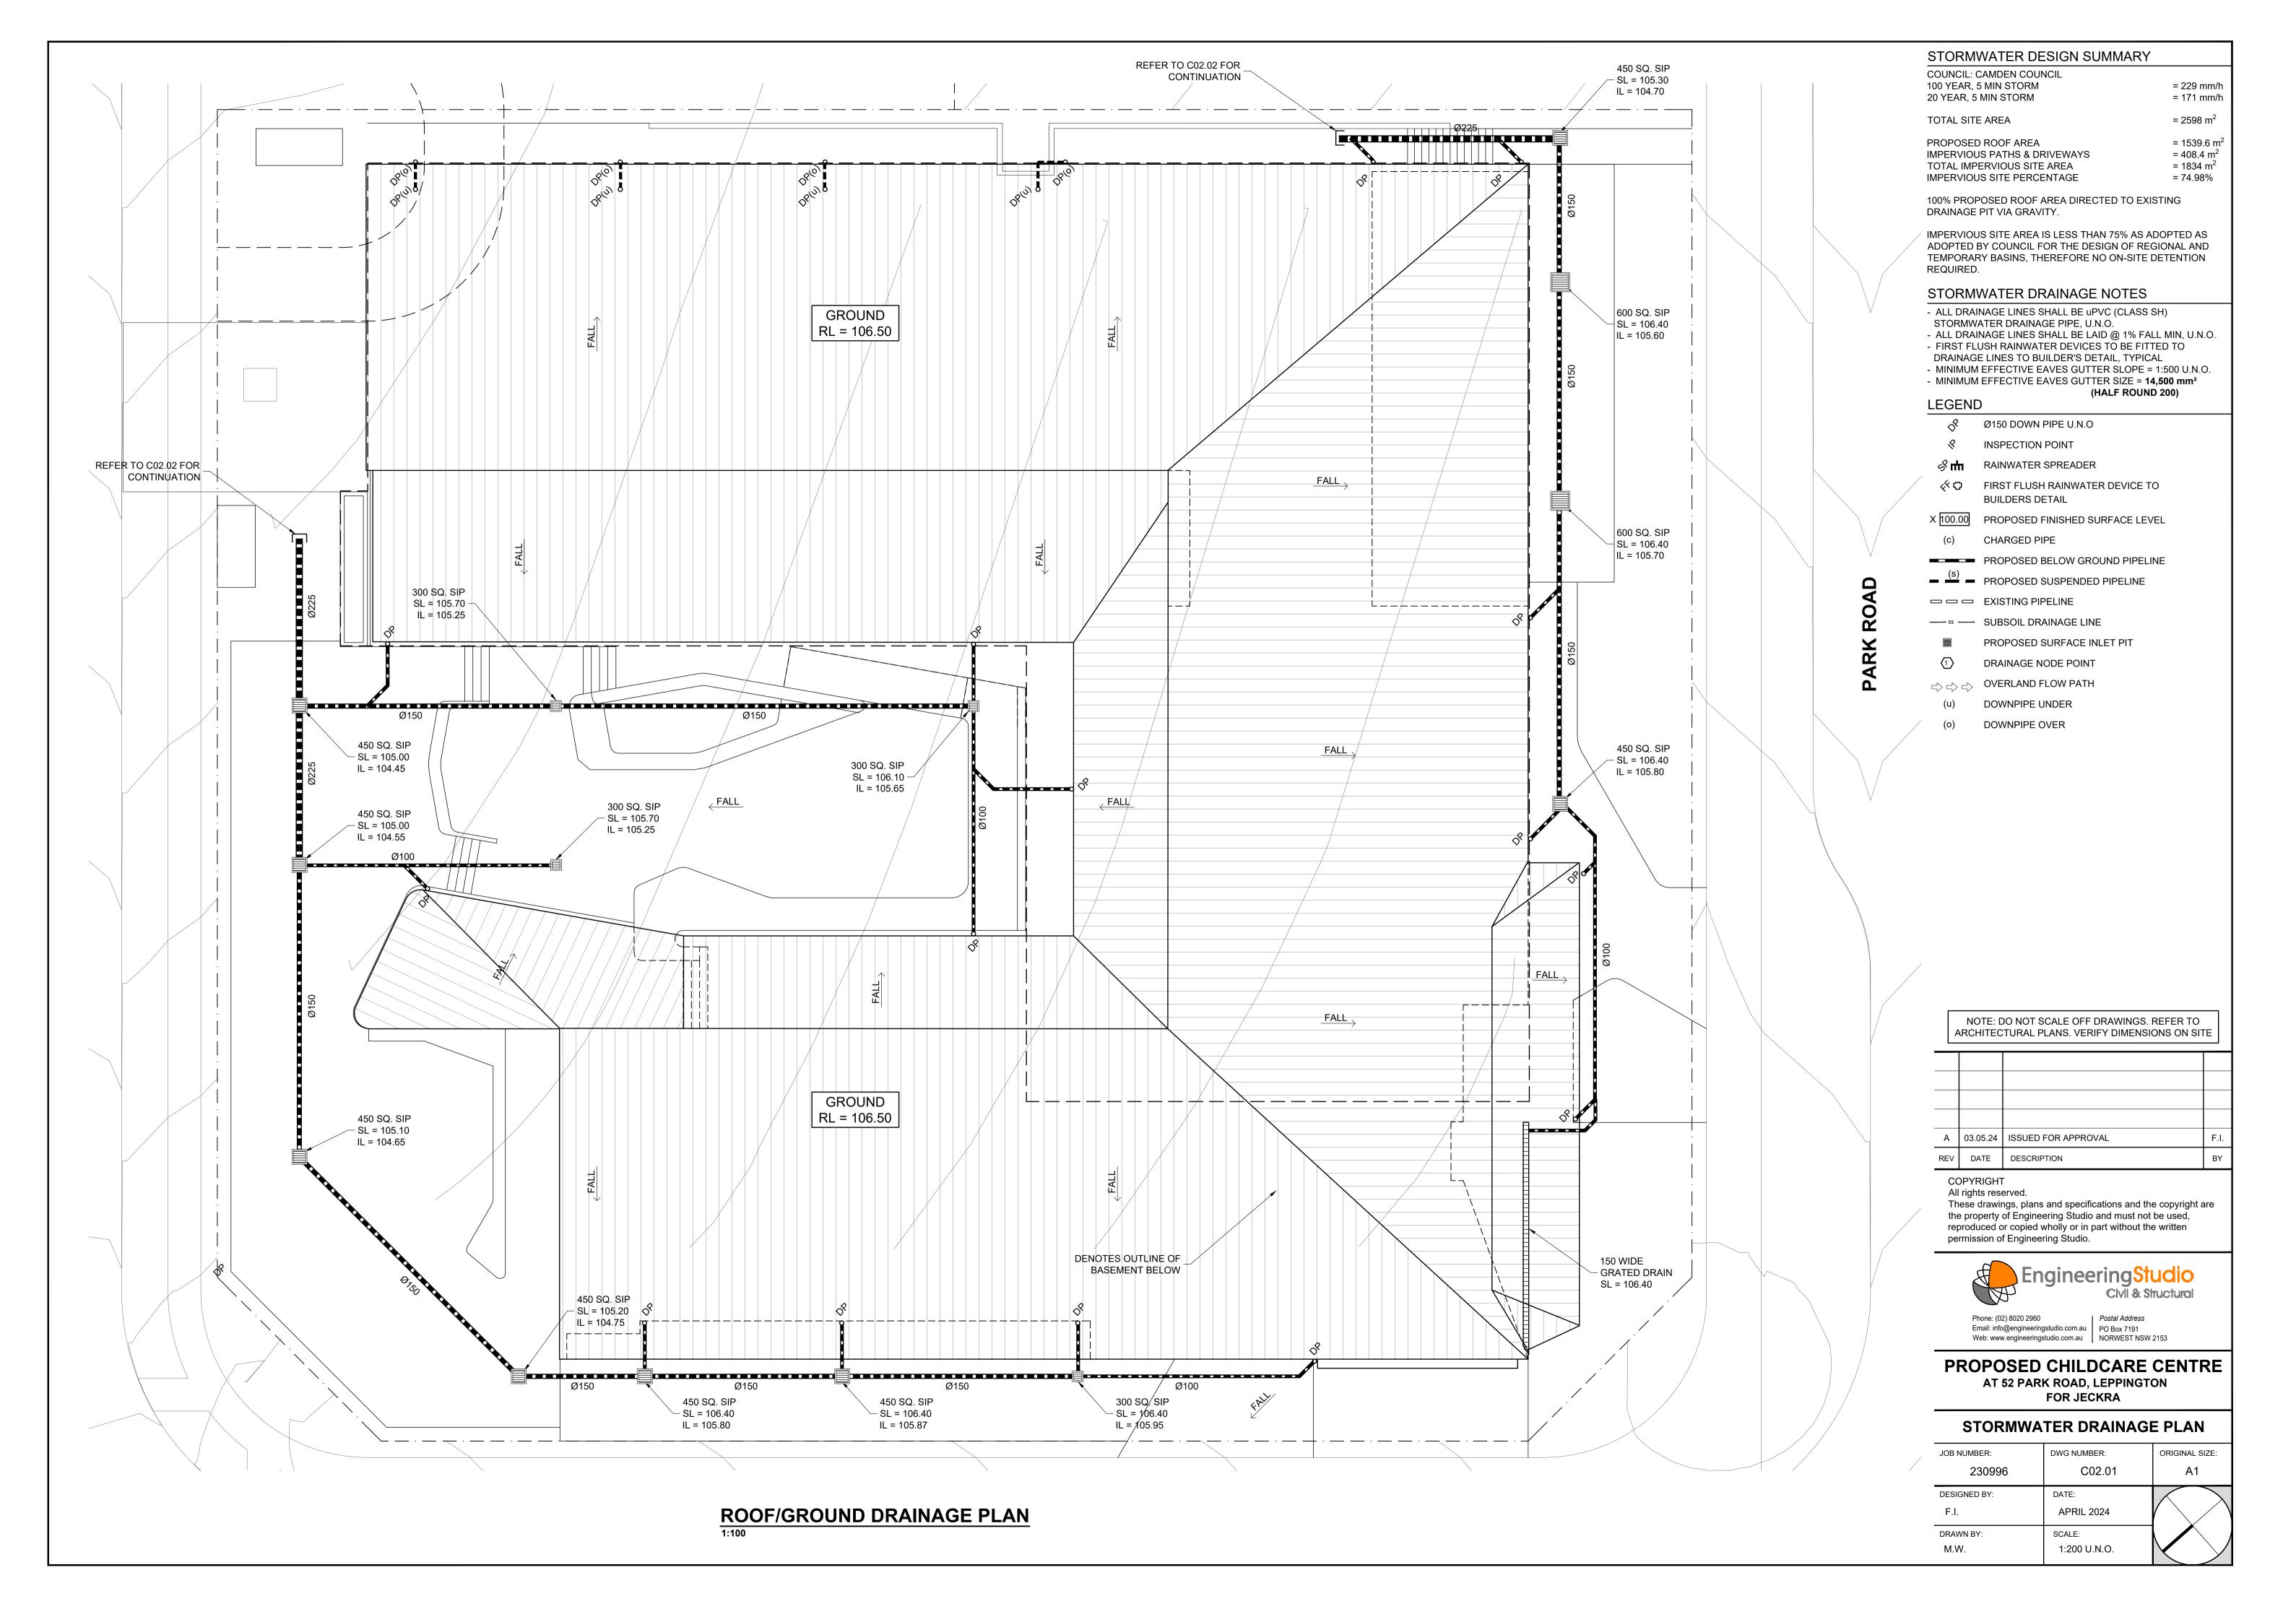
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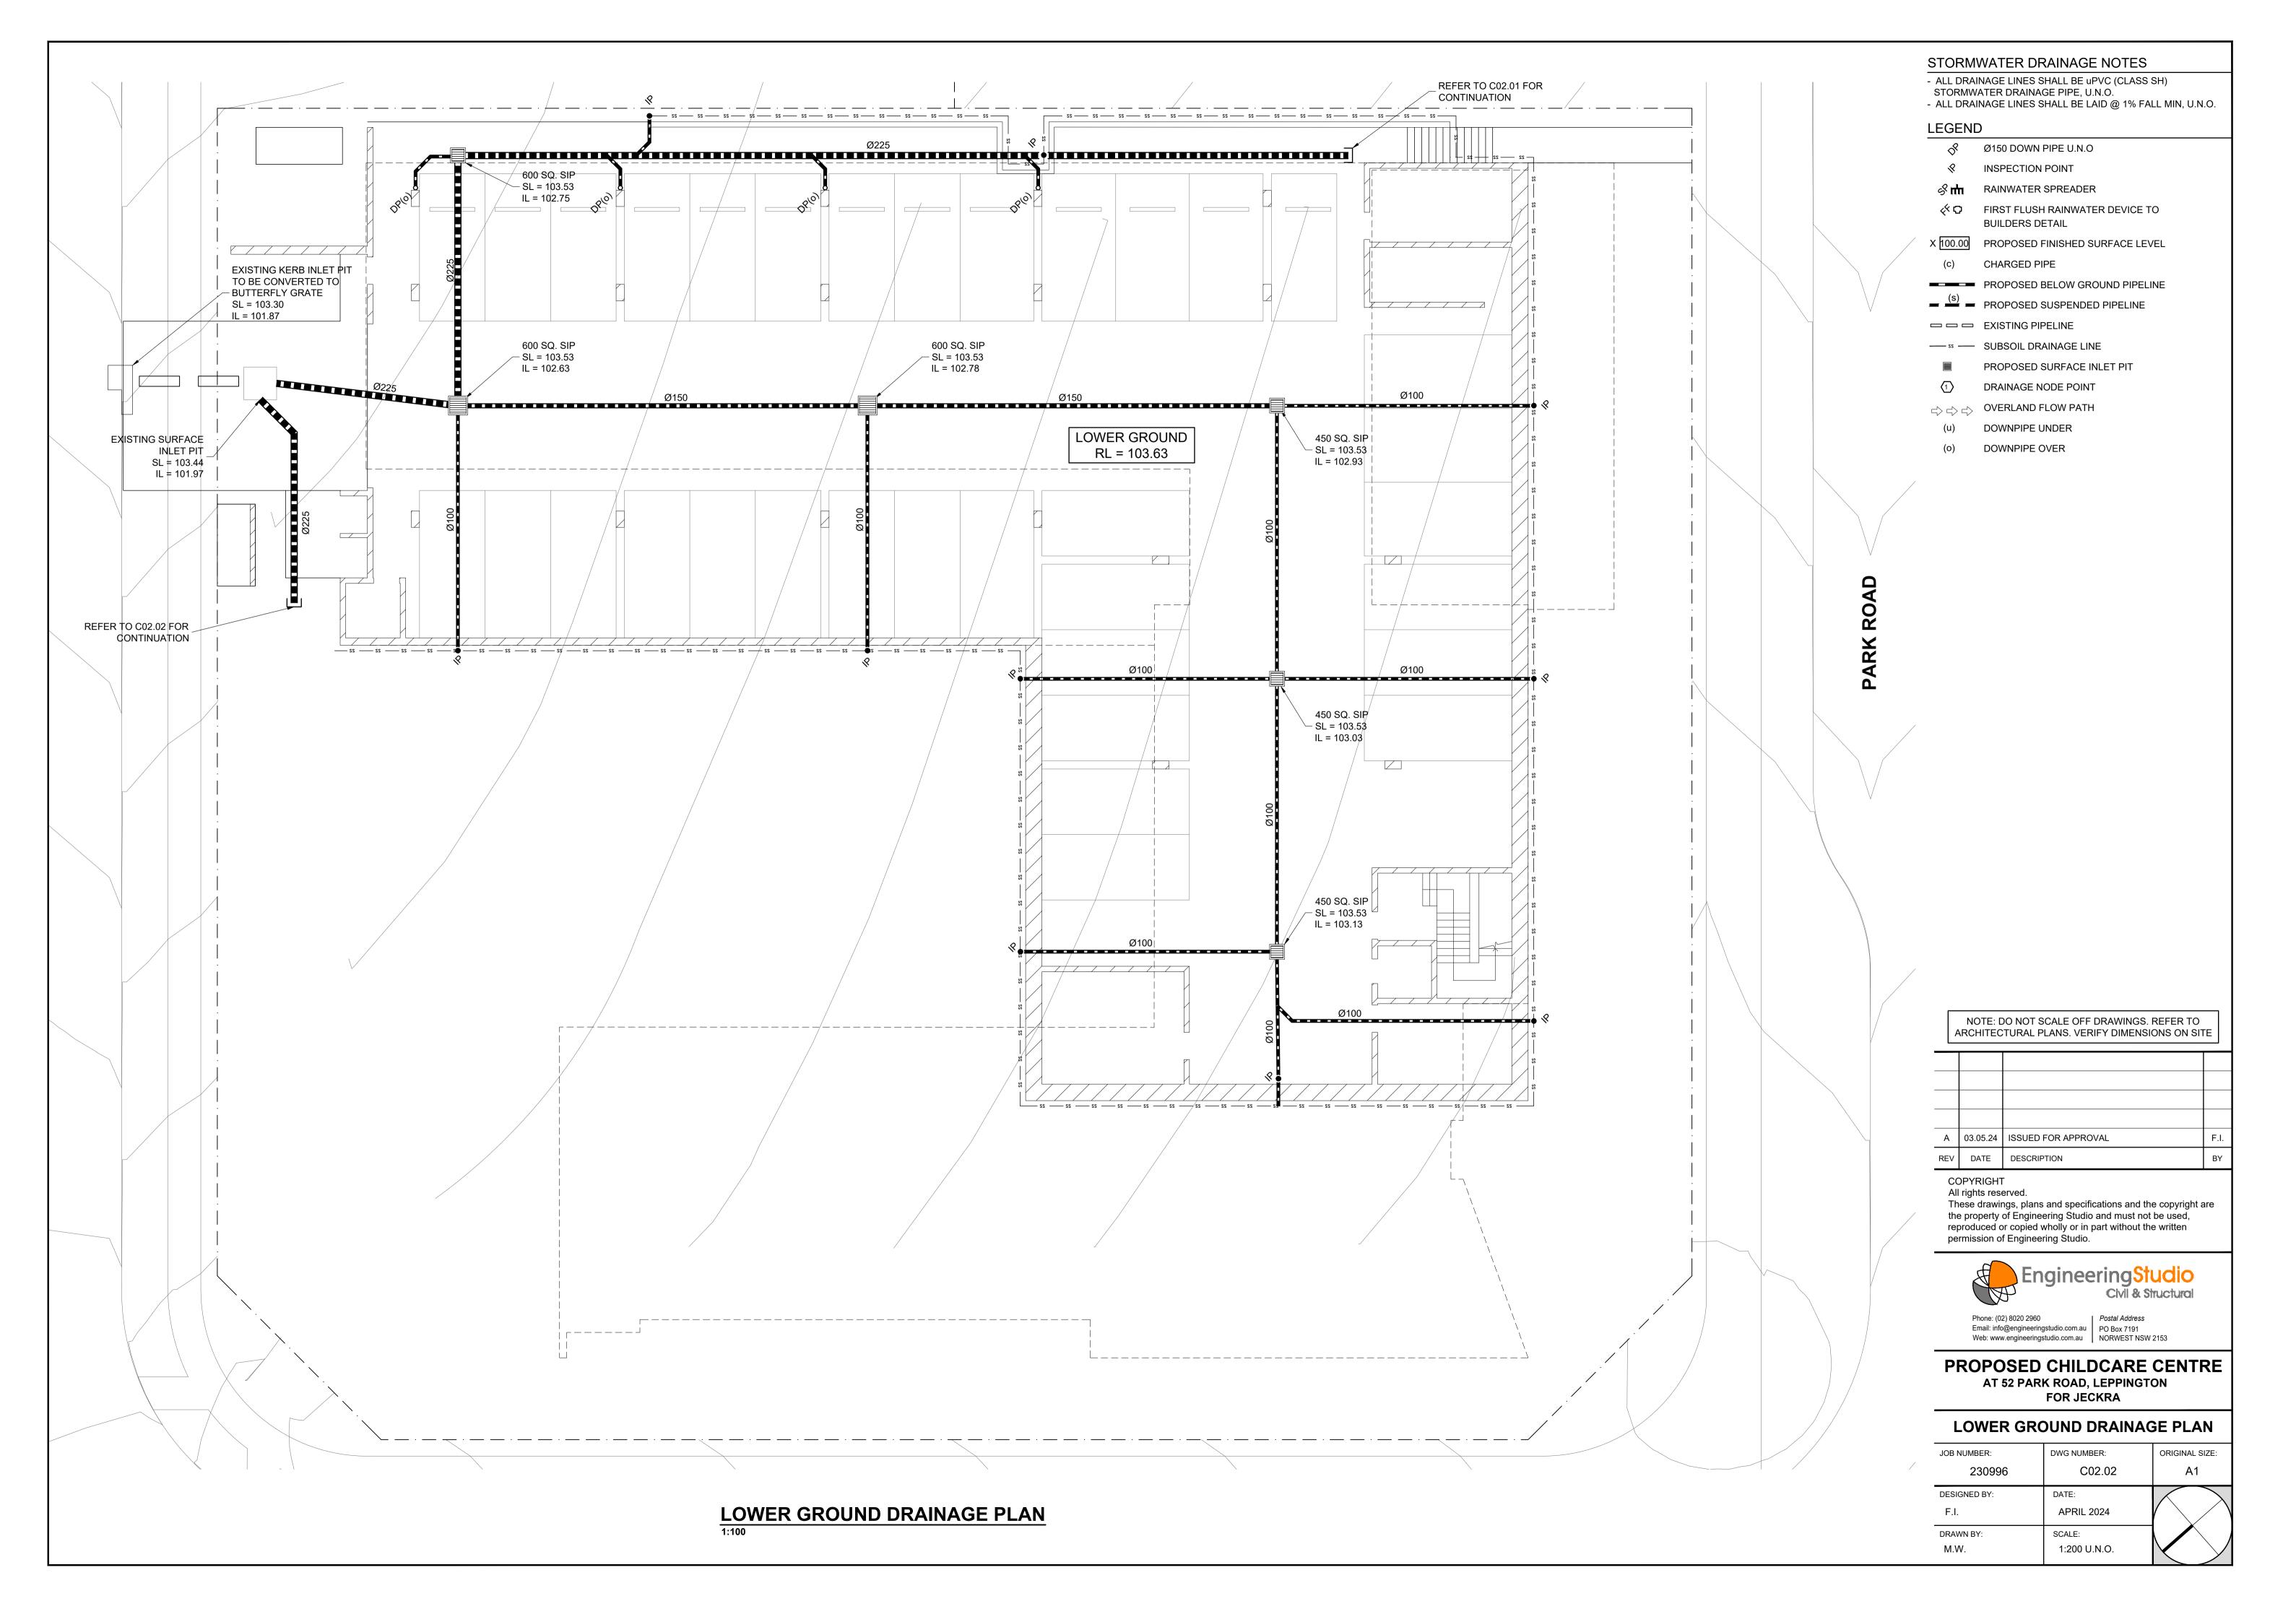
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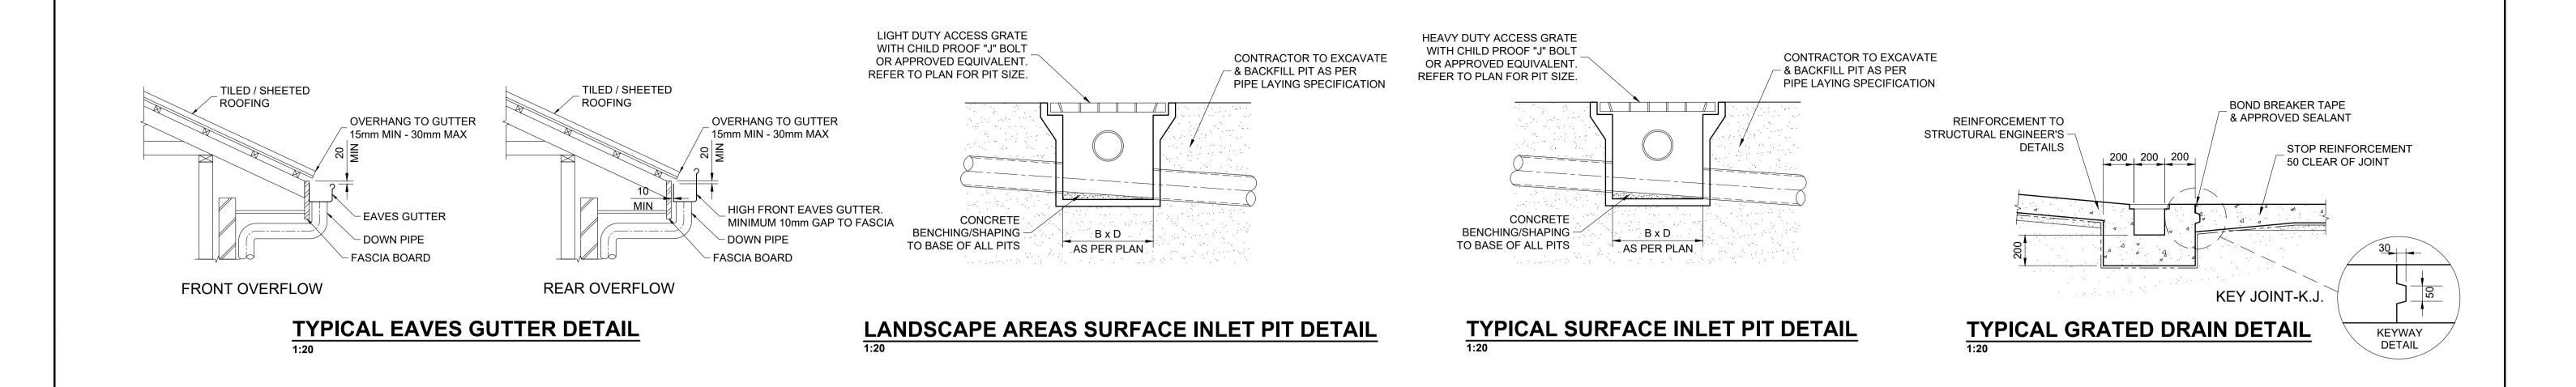
PROPOSED CHILDCARE CENTRE AT 44-52 PARK ROAD, LEPPINGTON **FOR JECKRA**


SEDIMENT & EROSION CONTROL PLAN

JOB NUMBER:	DWG NUMBER:	ORIGINAL SIZE:
230996	C01.01	A1
DESIGNED BY:	DATE: APRIL 2024	
DRAWN BY:	SCALE:	
M.W.	1:200 U.N.O.	







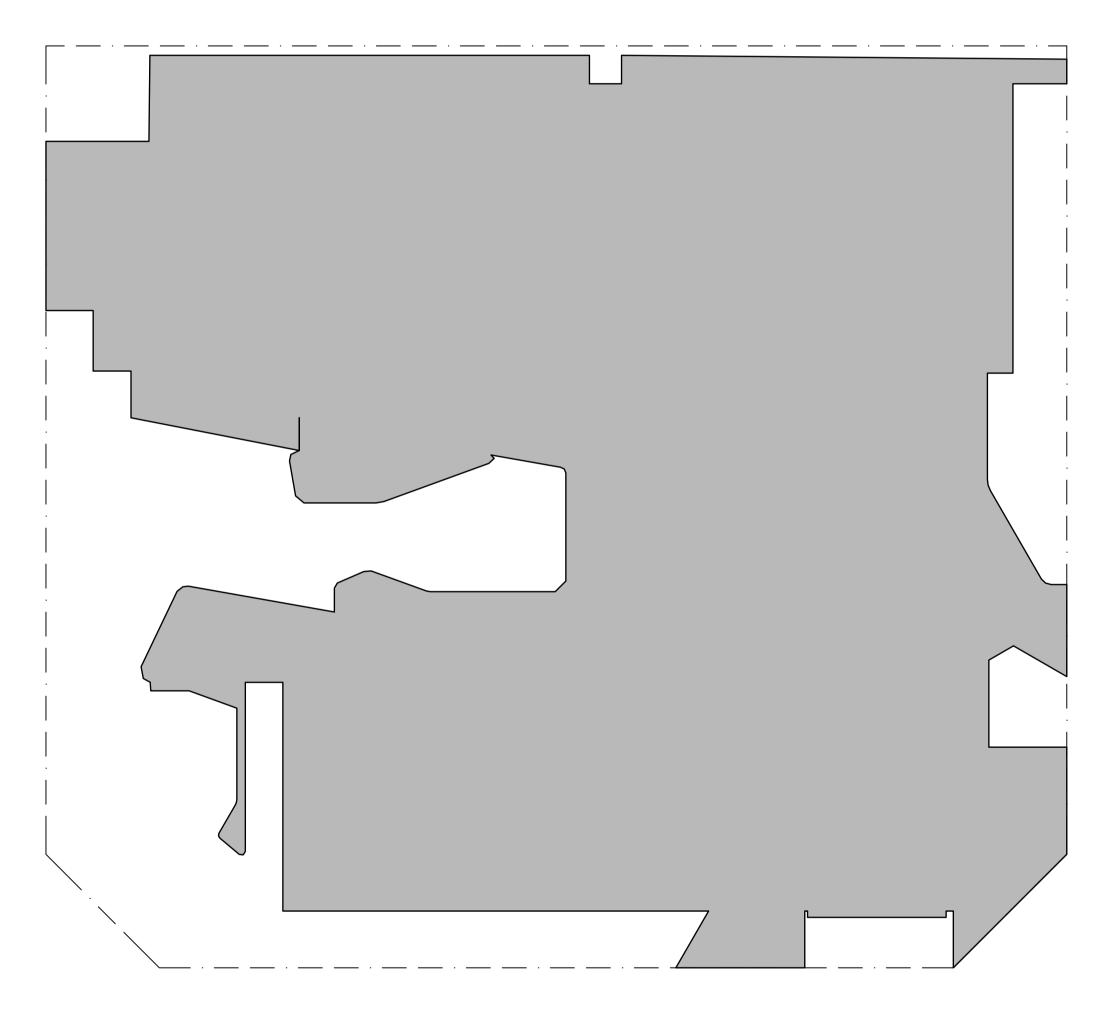

POST-DEVELOPMENT IMPERVIOUS AREA

NOTE: DO NOT SCALE OFF DRAWINGS. REFER TO ARCHITECTURAL PLANS. VERIFY DIMENSIONS ON SITE

			_	
	·			
	Α	03.05.24	ISSUED FOR APPROVAL	F.I.
·	REV	DATE	DESCRIPTION	BY

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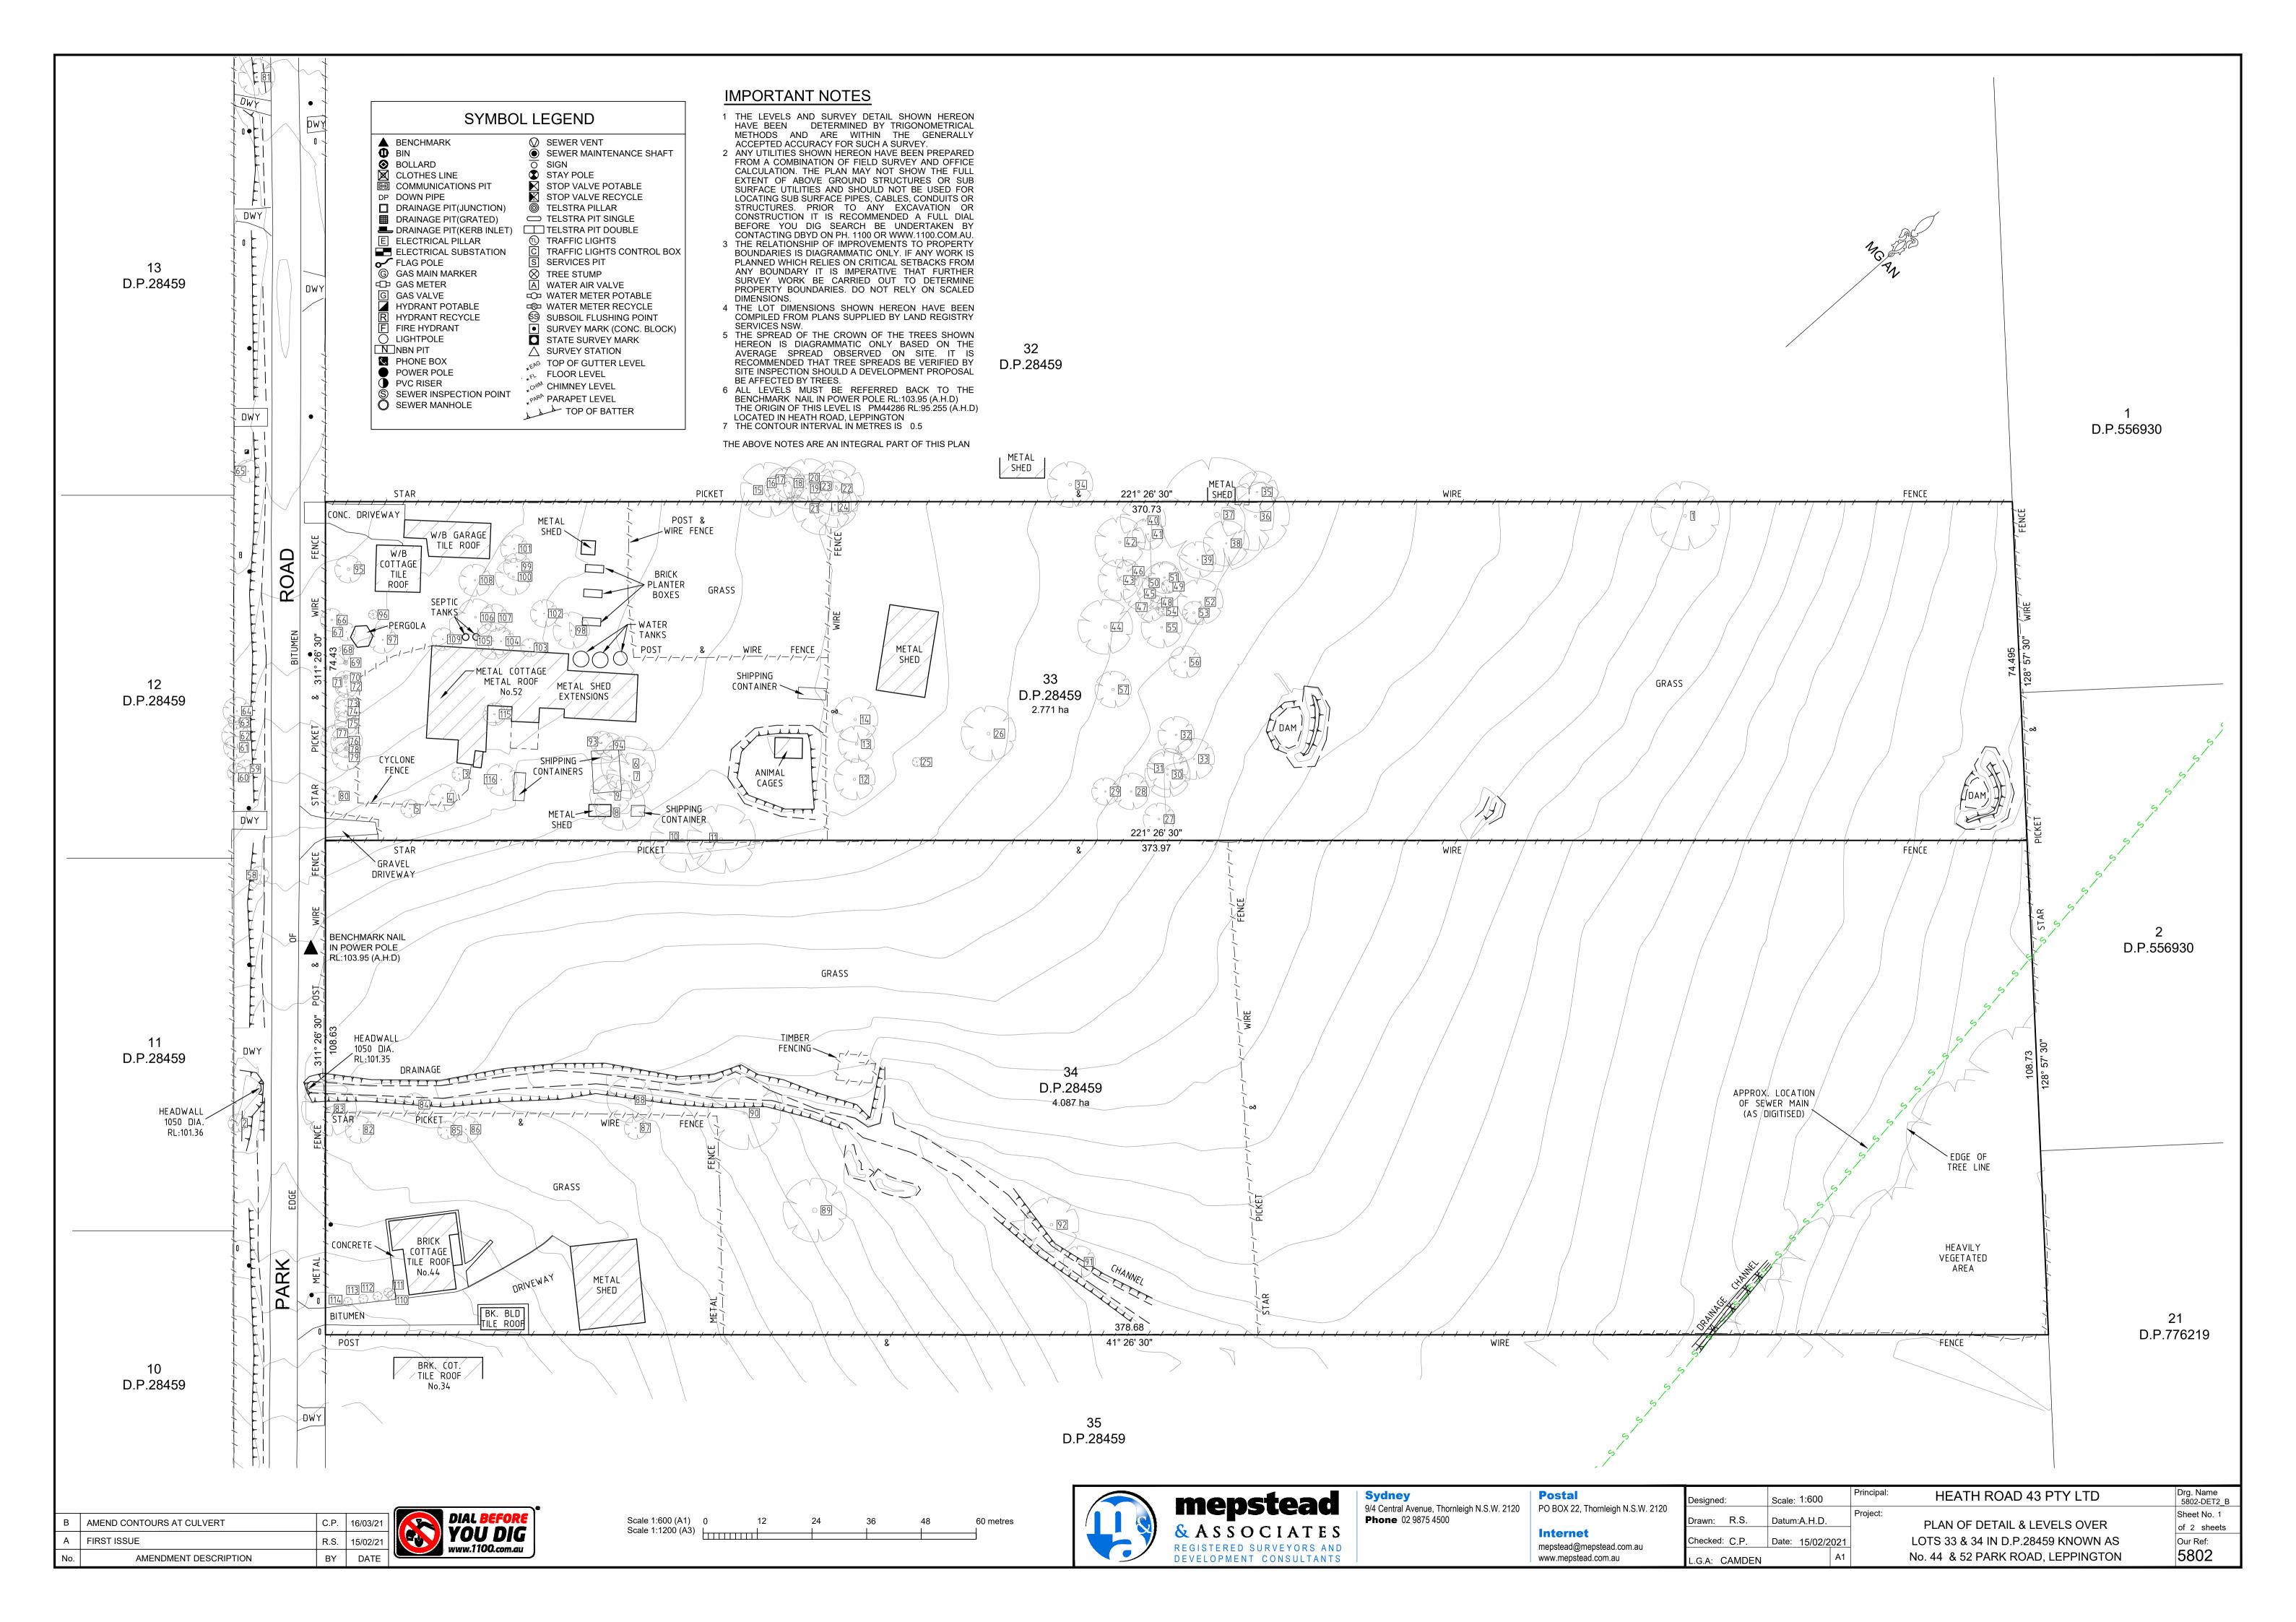
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PO Box 7191
NORWEST NSW 2153


PROPOSED CHILDCARE CENTRE AT 52 PARK ROAD, LEPPINGTON **FOR JECKRA**

STORMWATER DETAILS

JOB NUMBER:	DWG NUMBER:	ORIGINAL SIZE:
230996	C02.03	A1
DESIGNED BY:	DATE:	
F.I.	APRIL 2024	
DRAWN BY:	SCALE:	
M.W.	1:20 U.N.O.	



	TREE SCHEDULE										
TREE No.	SPREAD/TRUNK DIA./HEIGHT	LEVEL									
1	15/0.65/20		30	10/0.35/20	100.97	59	4/0.15/4	105.48	88	10/0.5/6	100.89
2	4/0.2/7	101.95	31	9/0.35/20	100.96	60	4/0.2/4	105.48	89	14/1/10	99.82
3	3/0.2/10		32	8/0.4/20	101.27	61	5/0.2/5	105.78	90	16/0.45/12	100.03
4	6/0.3/12		33	9/0.3/10	100.98	62	6/0.25/5	105.88	91	7/0.3/10	97.34
5	4/0.15/5	104.28	34	10/0.6/14		63	3/0.15/5	105.99	92	12/0.6/11	97.55
6	12/0.4/15	103.98	35	9/0.3/10	101.44	64	6/0.3/5	106.13	93	5/0.25/8	104.29
7	10/0.3/13	103.98	36	15/0.45/20	101.44	65	5/0.2/4	107.45	94	6/0.3/10	104.46
8	11/0.4/14	103.73	37	25/1.1/30	101.66	66	5/0.4/15	106.22	95	6/0.6/7	106.43
9	9/0.4/15	103.73	38	10/0.3/8	101.60	67	4/0.15/7	106.17	96	2/0.45/7	106.08
10	14/0.65/20	103.21	39	8/0.3/10	101.71	68	1/0.1/5	105.97	97	6/0.25/5	105.88
11	15/0.7/20	103.25	40	10/0.4/12	102.07	69	1/0.3/5	106.00	98	8/0.3/6	105.05
12	9/0.55/12	103.20	41	7/0.2/9	102.02	70	1/0.3/5	105.82	99	6/0.25/7	105.27
13	8/0.5/12	103.24	42	11/0.5/14	102.26	71	5/0.45/9	105.81	100	8/0.4/14	105.26
14	10/0.5/12	103.29	43	9/0.5/13	102.27	72	5/0.25/6	105.82	101	6/0.25/7	105.34
15	12/0.45/16	103.86	44	12/0.65/25	102.10	73	5/0.25/6	105.63	102	6/0.2/5	105.03
16	6/0.25/15	103.79	45	7/0.45/20	101.97	74	5/0.25/6	105.59	103	4/0.2/5	105.08
17	8/0.5/16	103.77	46	5/0.4/20	102.25	75	5/0.25/9	105.48	104	6/0.25/8	105.19
18	7/0.2/9	103.73	47	6/0.4/20	101.92	76	7/0.45/10	105.36	105	8/0.4/10	105.23
19	6/0.2/8	103.67	48	3/0.15/8	101.86	77	6/0.45/9	105.40	106	8/0.4/5	105.38
20	11/0.45/14	103.67	49	3/0.15/8	101.72	78	1/0.4/4	105.26	107	6/0.15/5	105.22
21	13/0.6/20	103.64	50	9/0.4/20	101.77	79	6/0.45/6	105.18	108	7/0.3/7	105.54
22	12/0.55/20	103.54	51	7/0.35/15	101.86	80	4/0.4/9	104.82	109	5/0.25/6	105.63
23	7/0.25/15	103.55	52	10/0.4/20	101.61	81	8/0.4/11	107.01	110	2/0.15/6	103.83
24	10/0.3/14	103.54	53	5/0.4/20	101.58	82	6/0.15/5	102.21	111	2/0.15/6	103.79
25	2/0.2/8	102.84	54	3/0.25/20	101.71	83	12/0.6/5	101.94	112	2/0.15/6	103.86
26	12/0.65/8	102.61	55	9/0.4/20	101.78	84	5/0.2/5	101.60	113	2/0.15/6	103.82
27	7/0.4/20	101.06	56	7/0.35/20	101.42	85	4/0.15/5	102.04	114	2/0.15/6	103.91
28	8/0.4/20	101.32	57	8/0.5/20	101.90	86	6/0.2/4	101.97	115	5/0.3/10	105.15
29	6/0.3/8	101.63	58	4/0.15/6	104.64	87	5/0.2/6	101.20	116	7/0.2/6	104.37

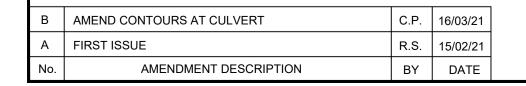



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	Internet mepstead@mepstead.com.au www.mepstead.com.au	

Designed:	Scale: 1:600	Principal:	HEATH ROAD 43 PTY LTD	Drg. Name 5802-DET2_B
Drawn: R.S.	Datum:A.H.D.	Project:		Sheet No. 2
	Dettermy (1D.)		PLAN OF DETAIL & LEVELS OVER	of 2 sheets
Checked: C.P.	Date: 15/02/2021		2010 00 0.01 111 211 120 100 111 101 111 11	Our Ref:
L.G.A: CAMDEN	A1		No. 44 & 52 PARK ROAD, LEPPINGTON	5802